

# Planning Committee



**GREATER CAMBRIDGE**  
SHARED PLANNING

# MAJOR APPLICATIONS

**23/04686/FUL**

Page 3

**Demolition of the existing buildings, garages  
and hardstanding and the erection of 84  
residential units, car parking, landscaping and  
associated works**

**12 - 34 Fanshawe Road**

# Existing Site



Coleridge Recreation Ground

Allotments

Communal Gardens and Protected open Space

Access to Recreation ground

Hard-standing washing drying area

Existing Garages on Site

Existing 3 Storey apartments


Sub station

Protected Open Space

Page 4

# Existing Block Plan

Page 5

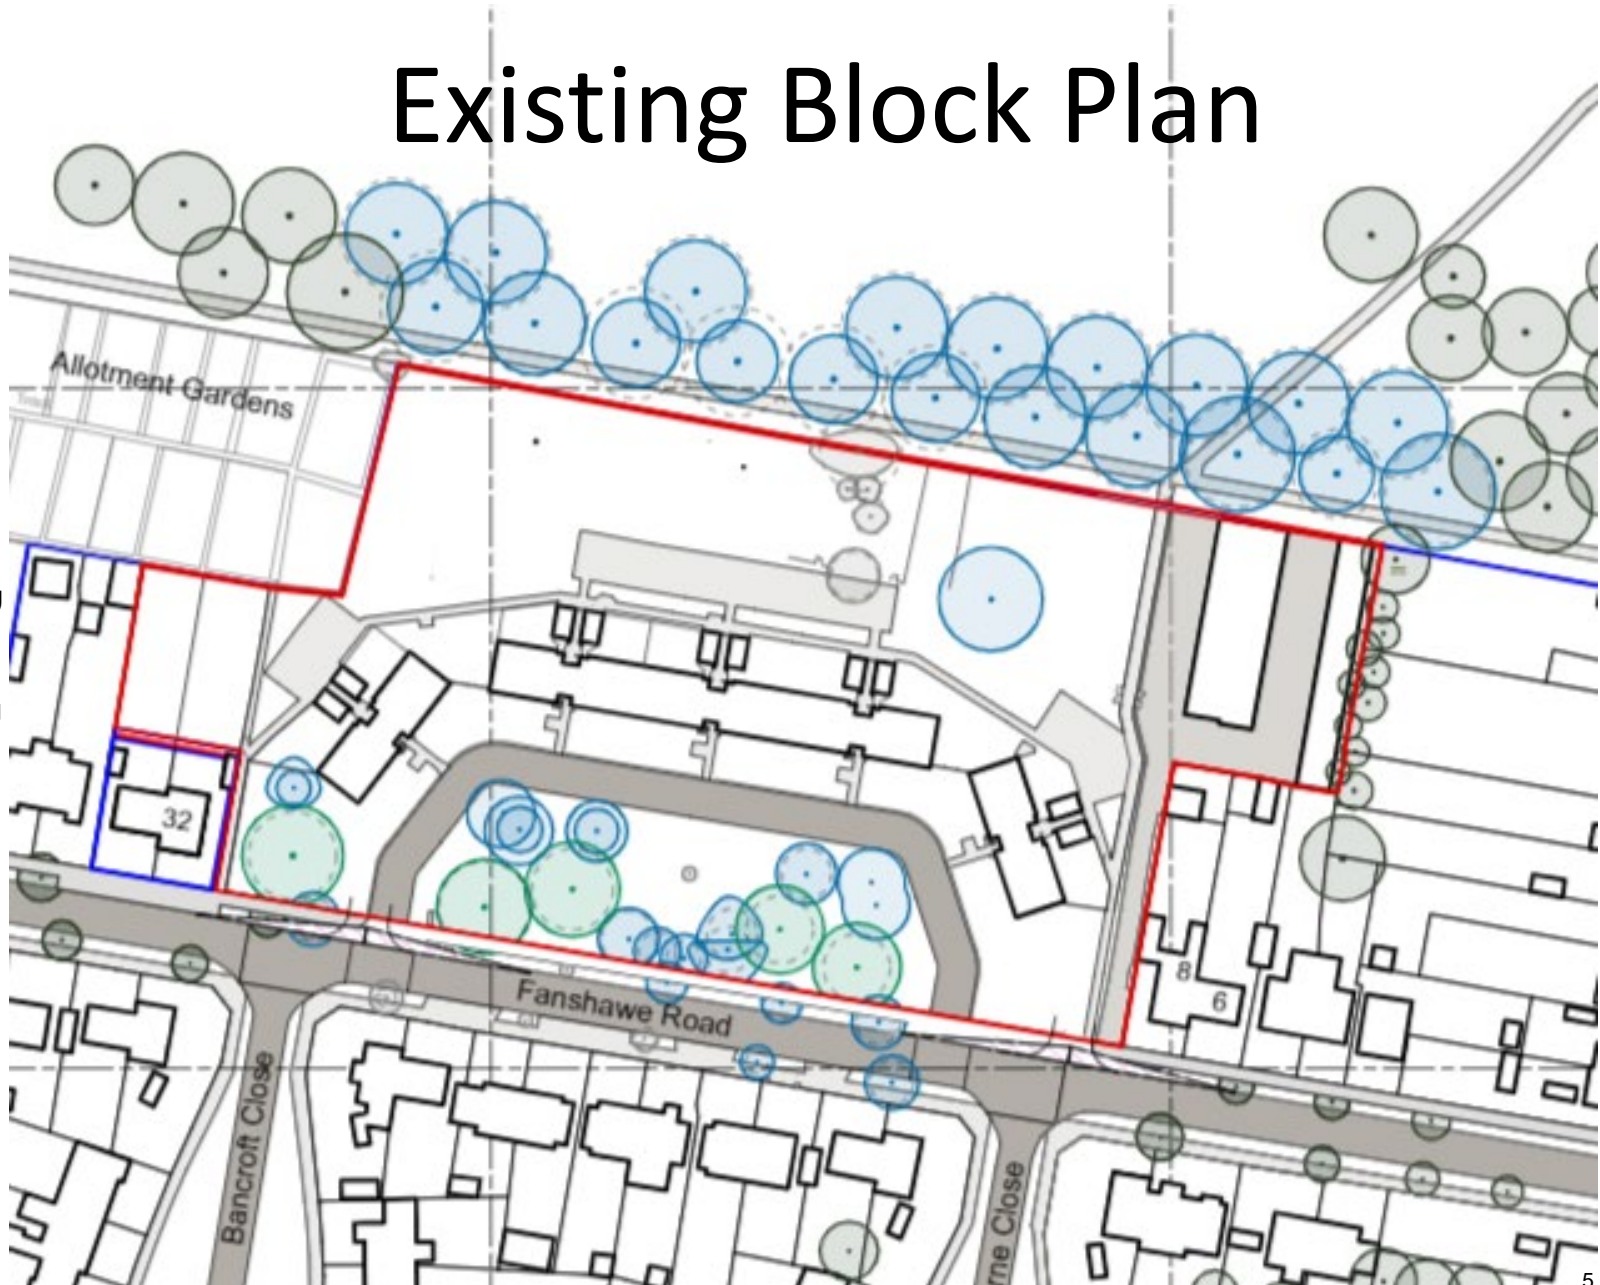

### 2.5 Existing Buildings

The existing 30 apartments have been determined to no longer meet the requirements of the residents, fall below current space standards, have very low thermal efficiency, and are in poor condition, with structural issues.

The site also contains low-quality and under-utilised green spaces and parking areas, and garages.



Page 6

1. Existing 3 storey flats on site



2. Existing garages on site



3. Existing Sub Station on perimeter of site



4. View of site from the centre of Coleridge Park



5. View from Bancroft Close



6. Looking west down Fanshawe Road



7. Looking east down Fanshawe Road




8. View from Coleridge Recreation Ground

# Protected Open Space

Page 7



Local Plan Proposal Map extract 2018

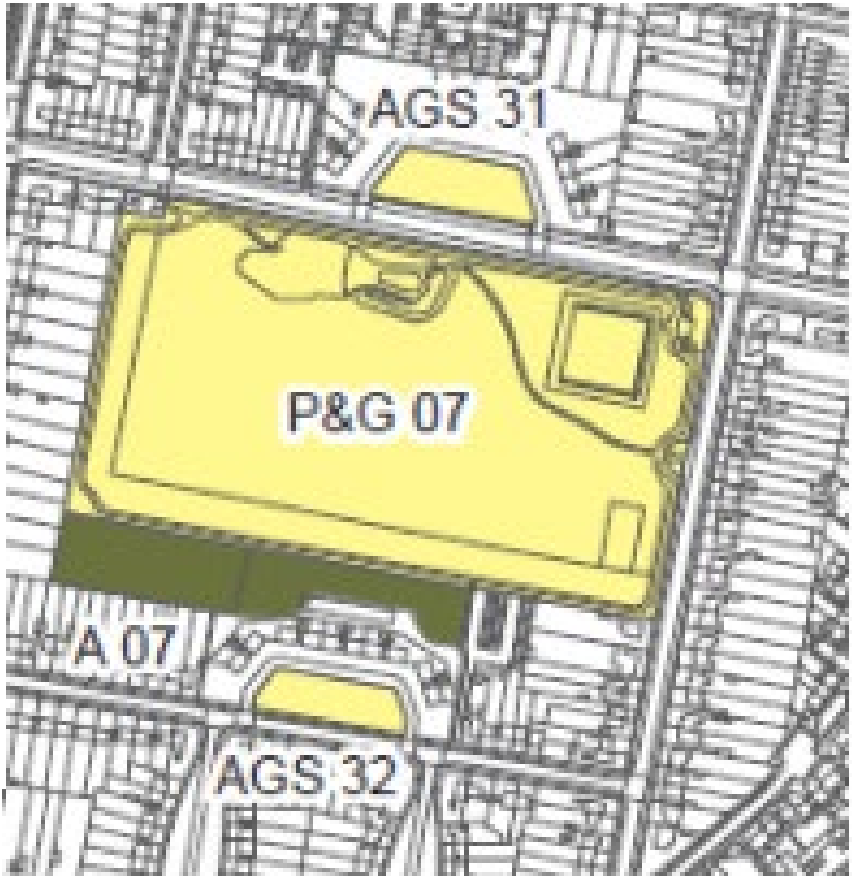











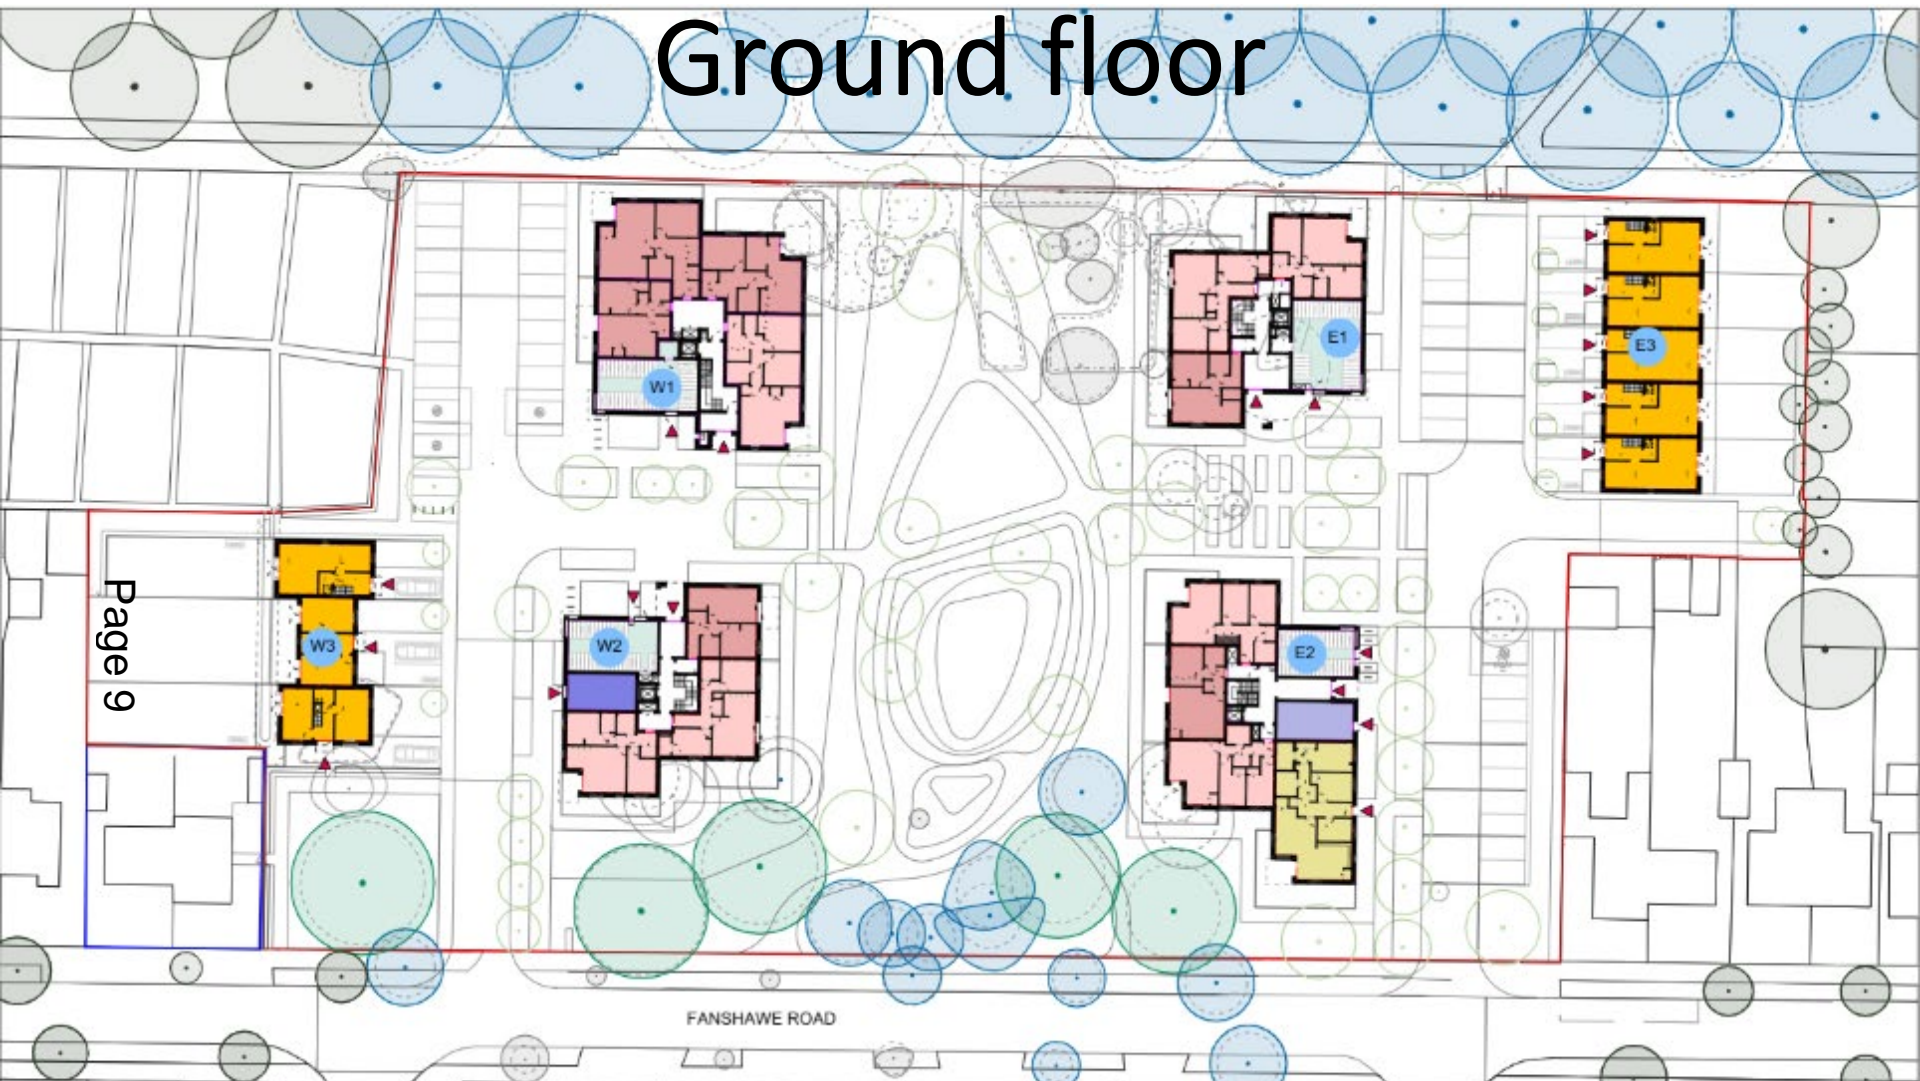





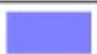

# Ground floor

Page 9



FANSHAW ROAD

LEGEND		160P APARTMENT		BIKE STORE		EXISTING TREE CAT A
		264P APARTMENT		PLANT ROOM		EXISTING TREE CAT B
		360P APARTMENT		UNSURVEYED EXISTING TREE		EXISTING TREE CAT C
		360P HOUSE		PROPOSED TREE		EXISTING TREE TO BE REMOVED
						

<b>Fanshawe Road</b> Fanshawe Road, Carbridge Cambridge Road School, Carbridge	
Cell No:	2105
Comp. No:	L_120
Title: <b>Ground Floor Layout Plan</b>	
Disc No:	PLANNING
Scale:	1:500 @ A3
Date:	14/07/2023

## Mole

Mole Architects  
Floor 2, 31 South Street  
Cambridge  
CB1 1SU

Tel: 01223 915012  
www.molearchitects.co.uk


DON'T SCALE FROM THIS DRAWING. VERIFY ALL DIMENSIONS ON SITE. DRAWINGS SHOULD BE READ IN CONJUNCTION WITH INFORMATION FROM ALL OTHER DESIGN CONSULTANTS AND CONTRACTORS. ALL DRAWINGS IN DIGITAL FORMAT ARE FOR REFERENCE ONLY.

PL4	27/10/2023	Client Updates
PL3	15/10/2023	Revision
PL2	27/09/2023	Revision
PL1	04/08/2023	Planning Issue
PL	14/07/2023	First Issue

Rev  
**PL4**

# First floor

Page 10

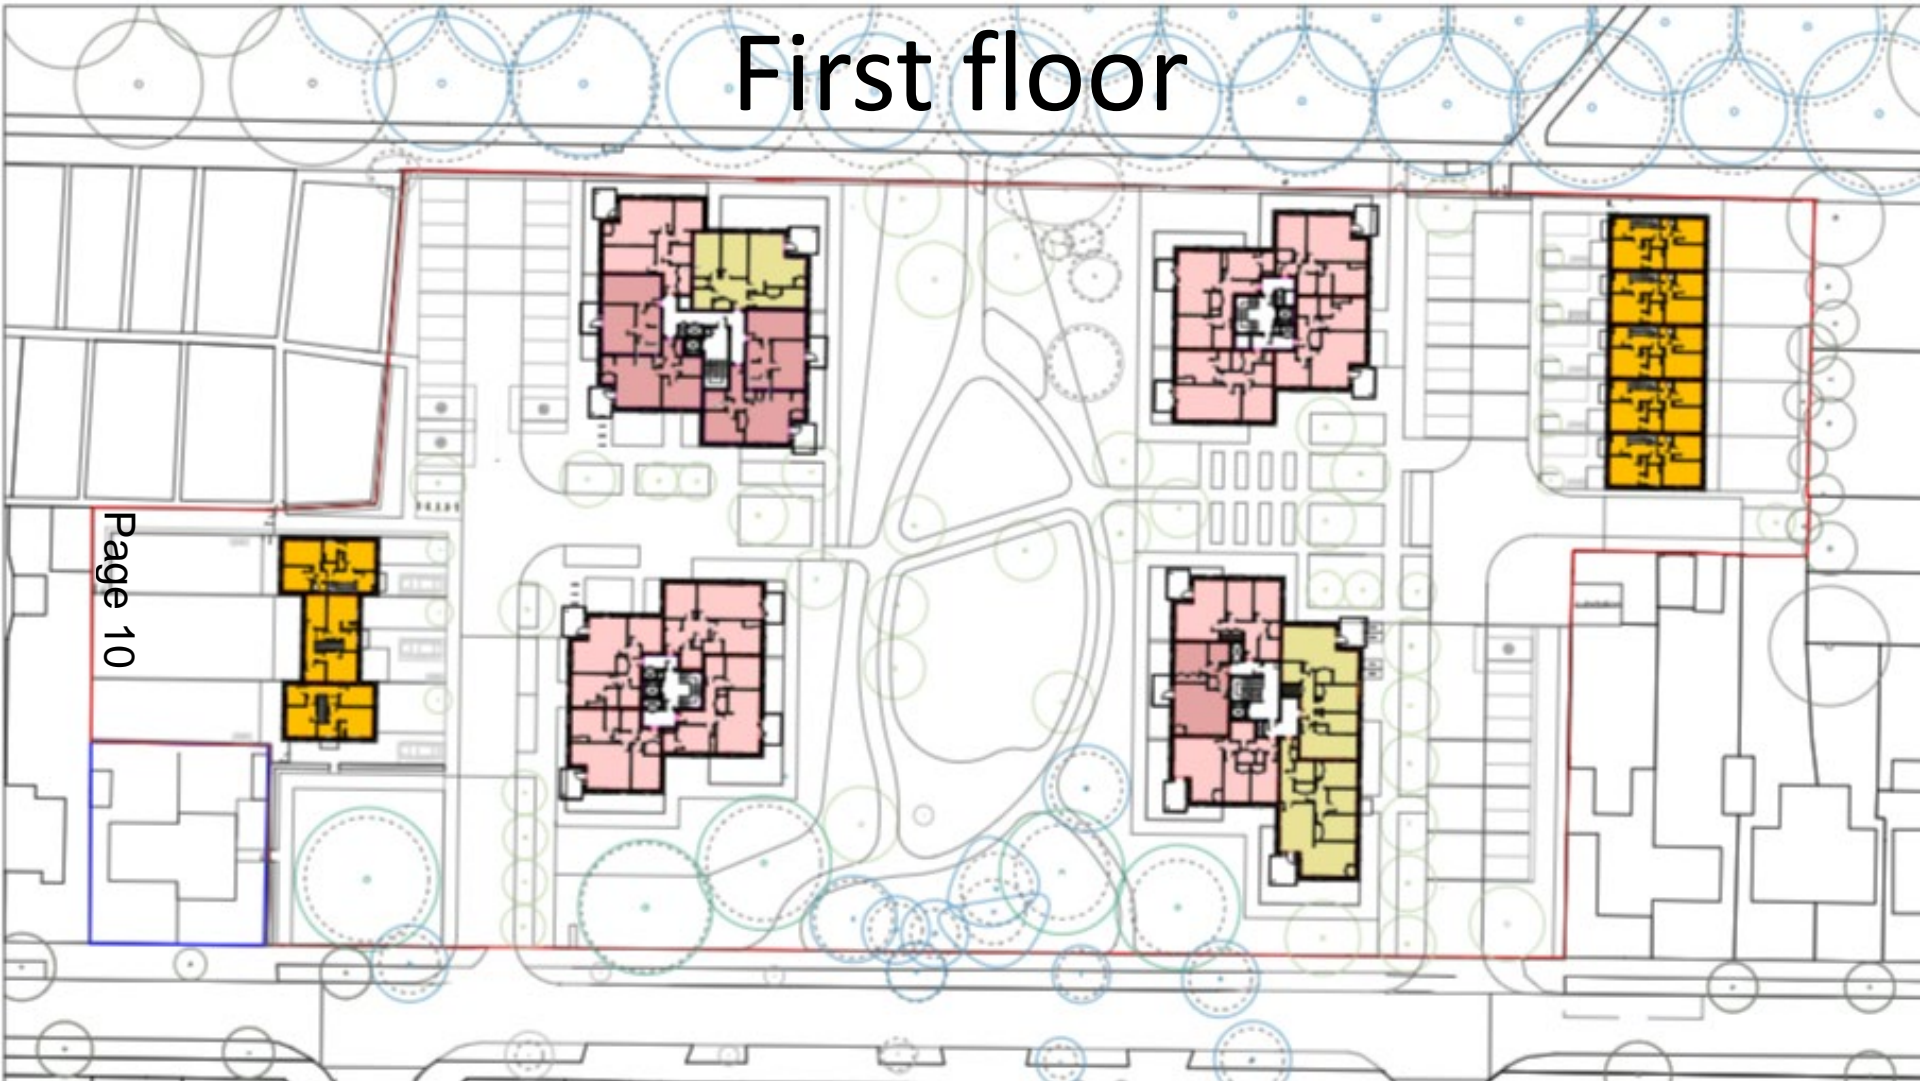

PL4	21/06/2023	Client Update
PL3	16/06/2023	Revision
PL2	21/06/2023	Revision
PL1	04/06/2023	Planning Issue
PL	14/07/2023	Final Issue

	NEW APARTMENT		SITE STONE		EXISTING TREE CAT A
	NEW APARTMENT		PLANT ROOM		EXISTING TREE CAT B
	NEW HOUSE		UNDESIGNED EXISTING TREE		EXISTING TREE CAT C
	NEW HOUSE		PROPOSED TREE		EXISTING TREE TO BE REMOVED



**Fanshawe Road**  
Fanshawe Road, Cambridge  
Cambridge Investment Partnership

JOB No. 2105  
Reg No. L 121

Title: **First Floor Layout Plan**

Status: **PLANNING**  
Scale: 1:500 @ A3  
Date: 14.07.23

**Mole**




100 Woodhouse Lane, Cambridge CB2 3HT  
Tel: 01223 300920  
www.mole-architects.co.uk

DO NOT SCALE FROM THIS DRAWING. VERIFY ALL DIMENSIONS ON SITE. CHECKING SHOULD BE READ IN CONJUNCTION WITH INFORMATION FROM ALL OTHERS ON THIS CONSULTATION AND CONSTRUCTION. ALL DRAWINGS IN DIGITAL FORMAT ARE FOR REFERENCE ONLY.

Rev: **PL4**

# Design Proposal

## 4.5 Form and Scale : E1

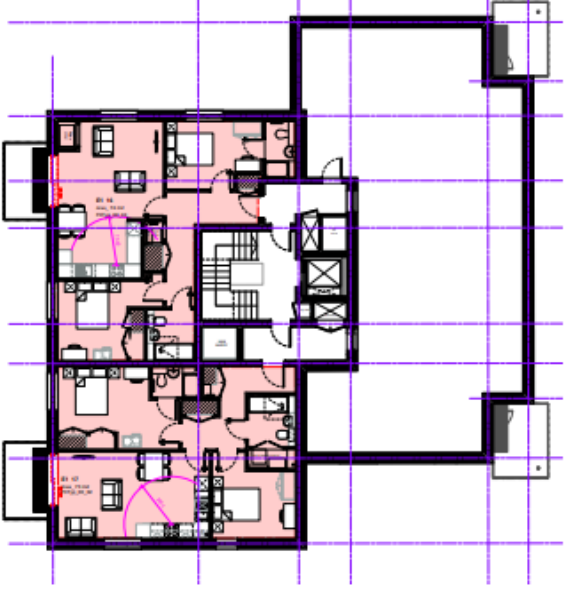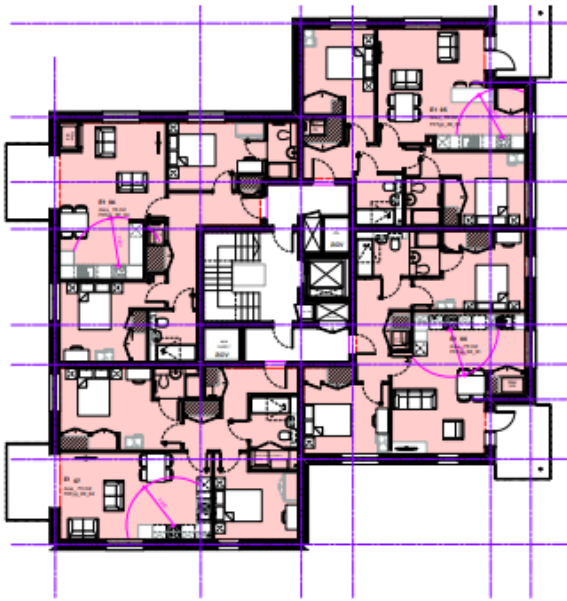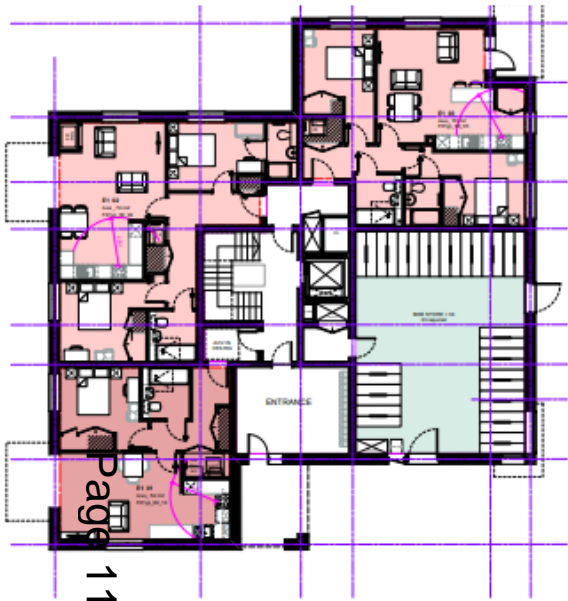





E1 Ground Floor Plan

E1 1st - 3rd Floor Plan

E1 4th Floor Plan

- 1B/2P Apartment
- Bike store
- 2B/4P Apartment

E1's entrance is recessed into the elevation and denoted by a glazed brick recess. The building has two recessed corner balconies to the east elevation to break up the scale of the building as perceived from the new E3 terraced houses. The building steps in height, going from four to five storeys. The five storey elements face the new park side. The height in the building steps with the step in plan.

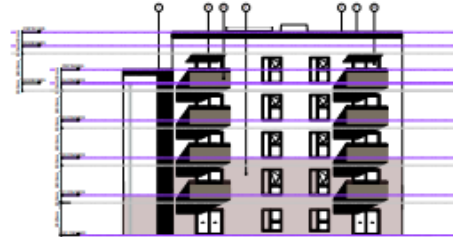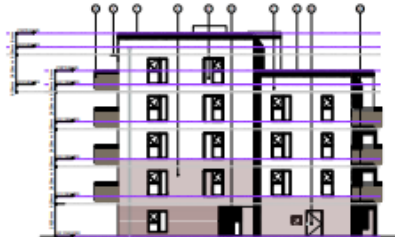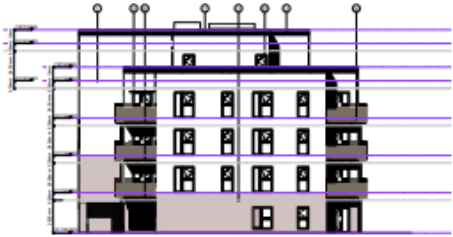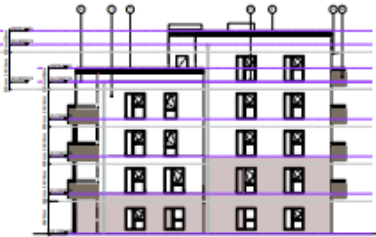

North Elevation

East Elevation

South Elevation


West Elevation

# Design Proposal


## 4.5 Form and Scale : E2

E2's entrance is recessed into the east elevation to activate the new street. The building is three and four storey in height. The building has four recessed corner balconies. The building steps in height to reduce the perceived mass of the building. The building has a four storey elevation to the new green space and three stories on the east side to provide a sensitive scale elevation to the adjacent existing houses.


Page 12

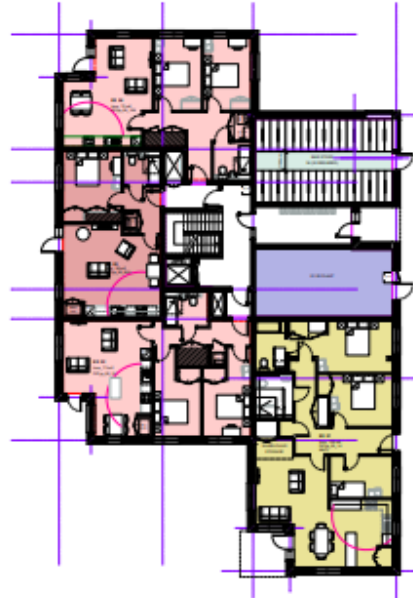

E2 Ground Floor Plan

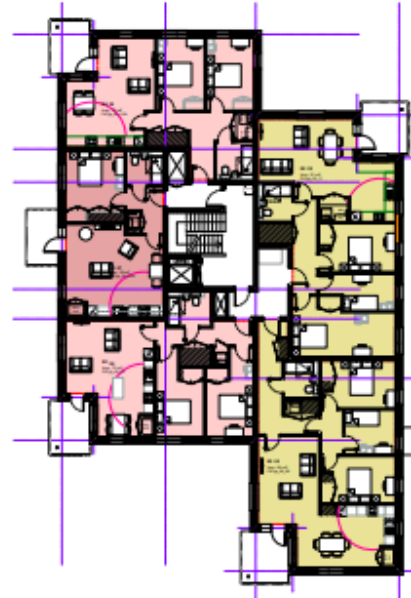

E2 1st - 2nd Floor Plan

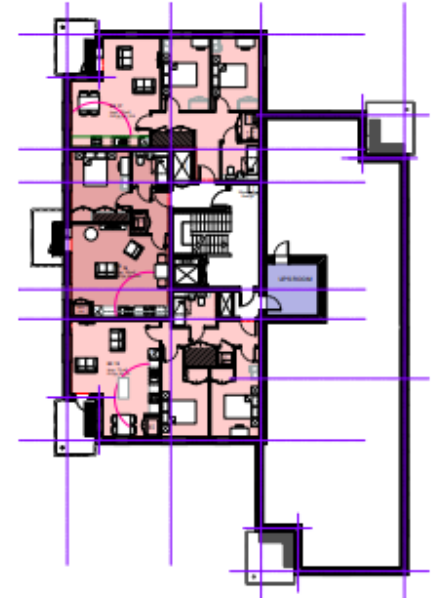


E2 3rd Floor Plan

- 1B/2P Apartment
- 2B/4P Apartment
- 3B/5P Apartment
- Bike store
- Plant



North Elevation

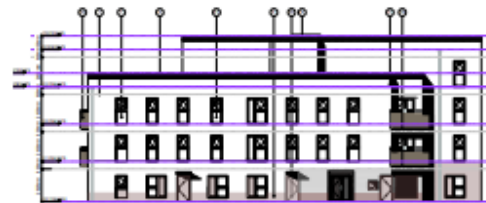

East Elevation



South Elevation



West Elevation

# Design Proposal


## 4.5 Form and Scale : E3

E3 is a row of five terrace homes. The west elevation provides passive overlooking of the recreation ground path. The homes are clad in white brick with a brown brick base. Brown brick banding around entrances denotes the main entrance and adds interest to the elevation. Window and door frames are in a matching red shade.


Bin stores are in timber clad structures to the front of the houses and provide space for covered cycle parking and a green bin. They also provide a location for the EV charging points on the side of the garden store.

3B/5P House


Page 13

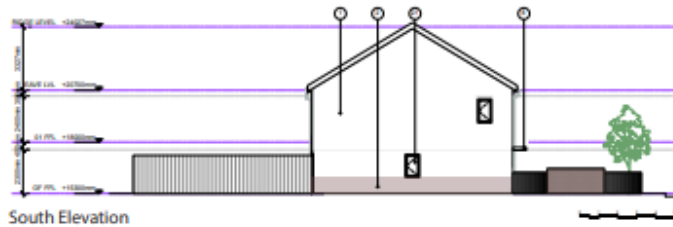

South Elevation

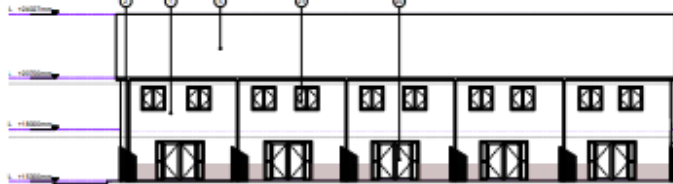


East Elevation

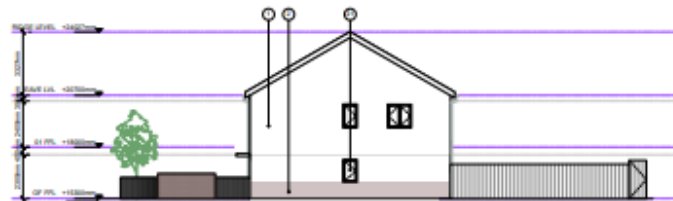


North Elevation



West Elevation

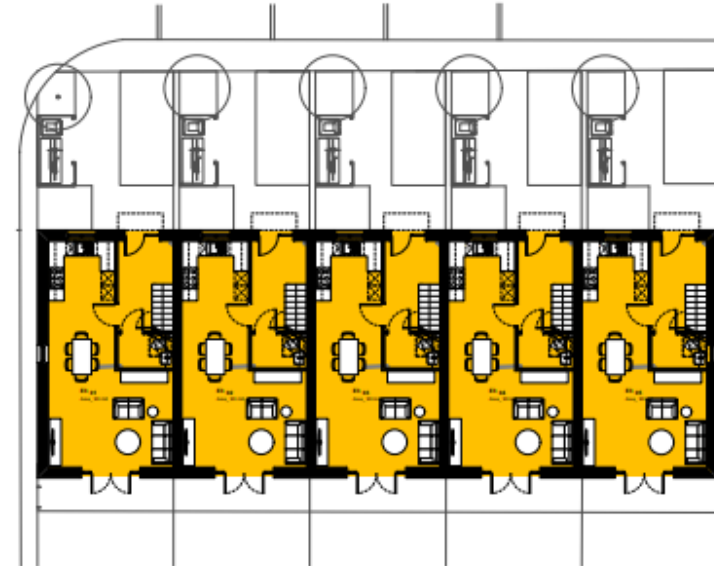

E3 Ground Floor Plan

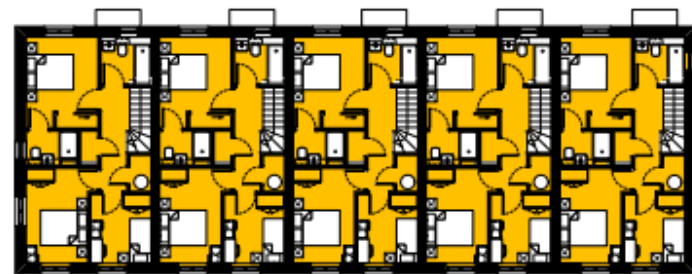

E3 First Floor Plan

# Design Proposal


## 4.5 Form and Scale : W1

W1 entrance is recessed into the elevation and denoted by glazed brick recess. The building has recessed corner balconies, with the brick walls and balcony finishes all matching and contrasting in red to the main body of the building. A vertical change in the brick colour to the main body of the building creates visual interest and creates a visual break in the height of the building.


Unsupported cantilevered balconies are in a finish matching the corner balconies to create a consistent visual contrast to the main body of the building.

This approach to the external materials is consistent on all four apartment buildings to create a cohesive strategy across the scheme and create a tenure blind scheme.

Page 14

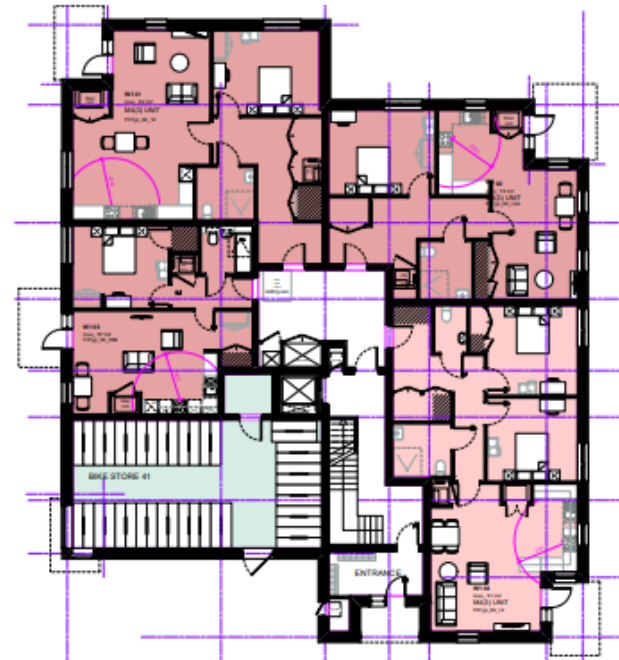

W1 Ground Floor Plan

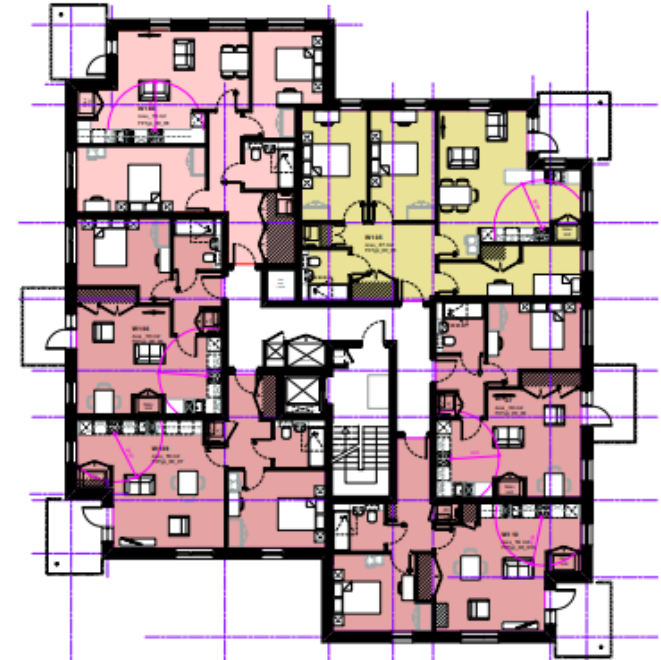

W1 1st - 4th Floor Plan




- 1B/2P Apartment
- 2B/4P Apartment
- 3B/5P Apartment
- Bike store
- Plant



North Elevation



East Elevation



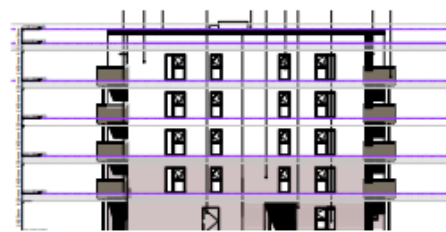


South Elevation



West Elevation

## 4.5 Form and Scale : W2

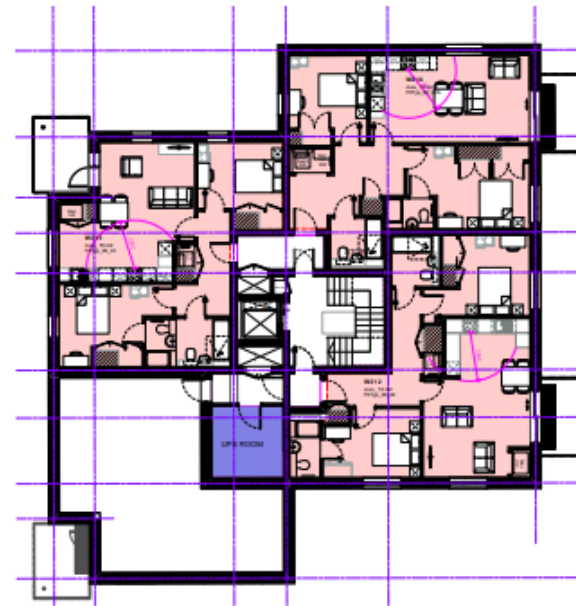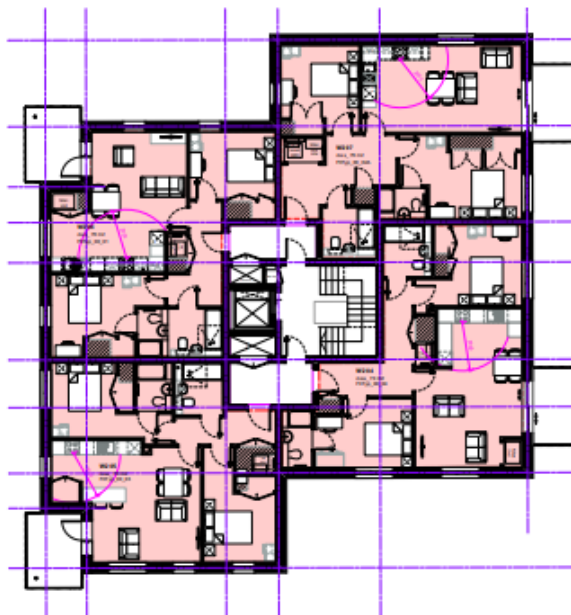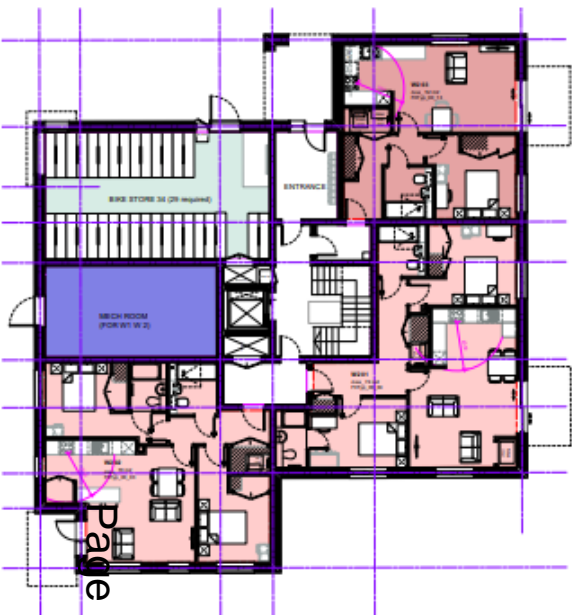




W2 Ground Floor Plan

W2 1st - 2nd Floor Plan

W2 3rd Floor Plan



W2's entrance is recessed into the elevation and denoted as a glazed brick recess. The building has two recessed corner balconies to the west elevation to break up the scale of the building. The building steps in height on the west and south elevations which are the most sensitive elevations facing onto the new terraced houses and onto Fanshawe road.

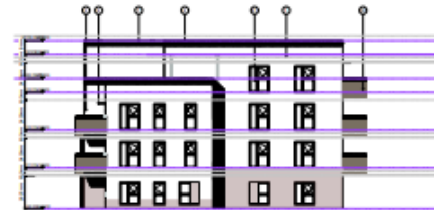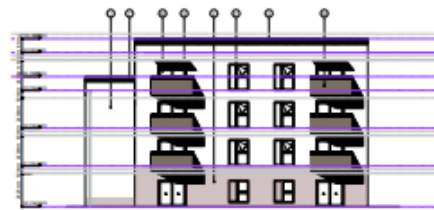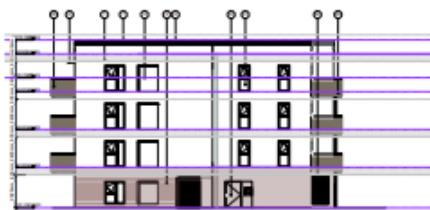

North Elevation

East Elevation

South Elevation


West Elevation

# Design Proposal

## 4.5 Form and Scale : W3

W3 is a row of three terraced houses. The gable ends bookend the central house to provide visual interest and provide a front elevations to the east and south. The main body of the building is white brick with a red brick base. Red brick banding around entrances denotes the main entrance and adds interest to the elevation. Window and door frames are in a matching red.


Bin stores are in a matching red brick to the front of the houses and provide space for covered cycle parking and a green bin. They also provide a location for the EV charging points on the side of the garden store.

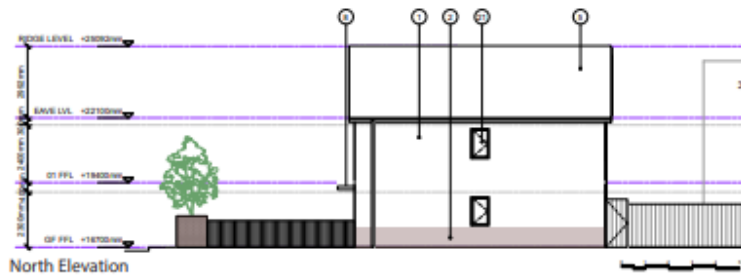

North Elevation




East Elevation

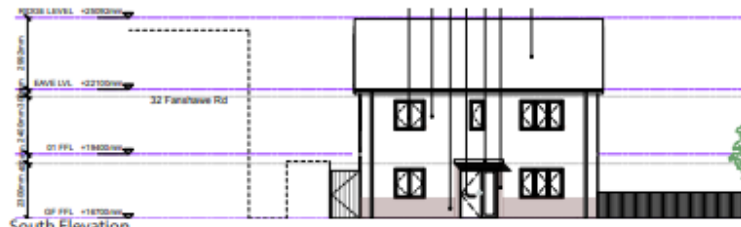


South Elevation



West Elevation

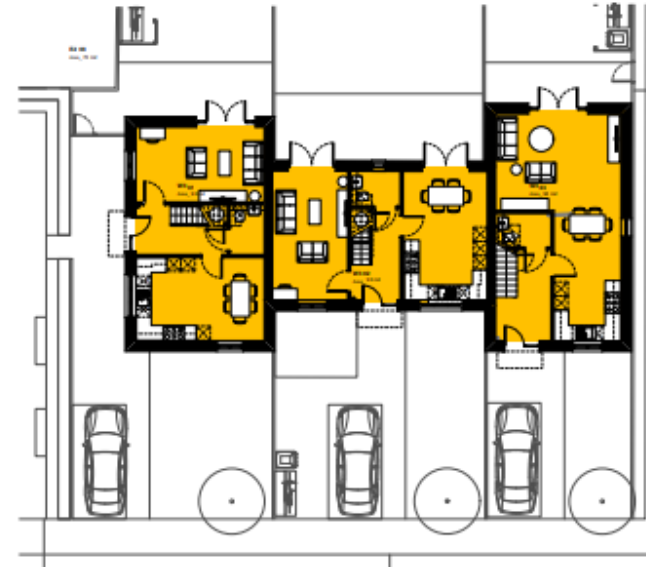


W3 Ground Floor Plan

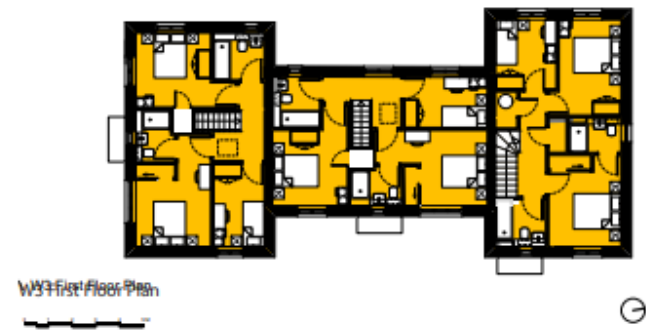

W3 First Floor Plan



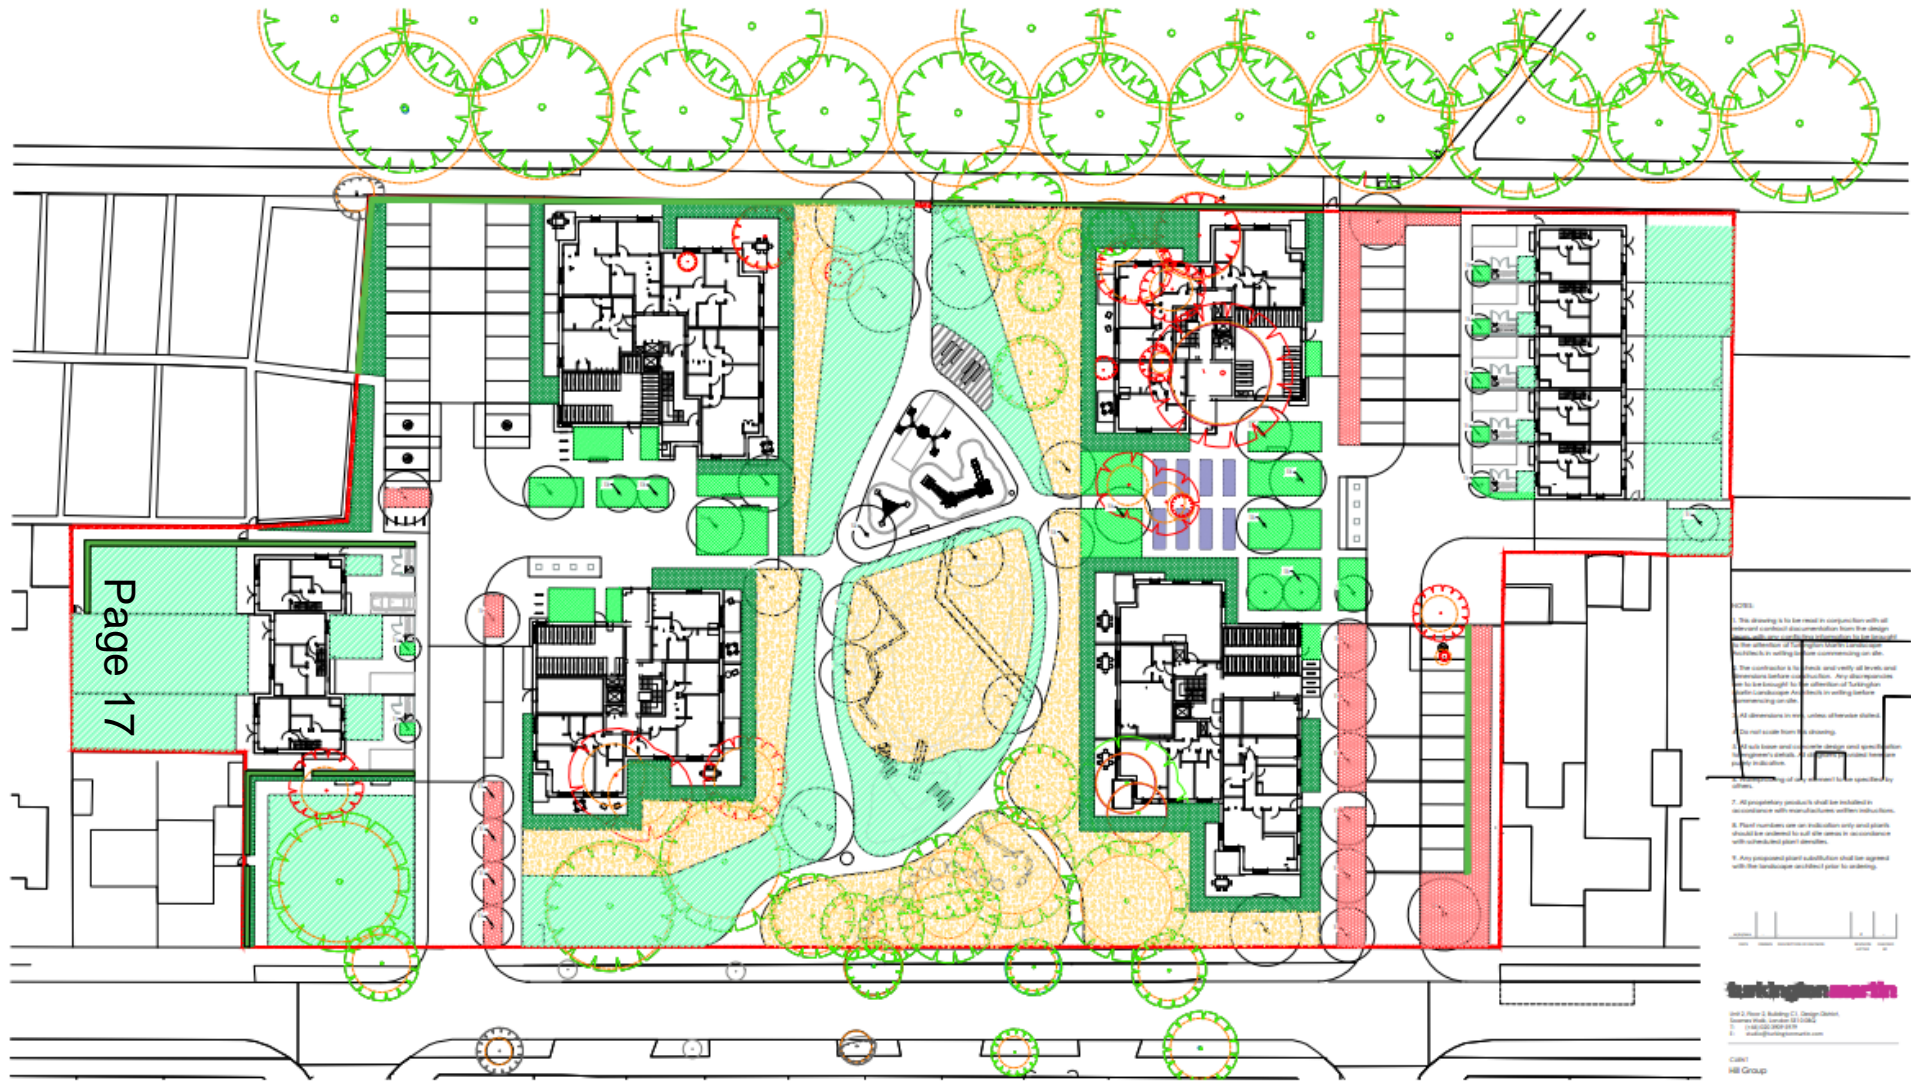

Page 17

- KEY**
- Works Boundary
  - Existing trees to be retained
  - Roof Protection Area
  - Trees to be removed

- PLANTING**
- P1 Defensible planting
  - P2 Wildflower turf
  - P3 Perennial planting
  - P4 Mown grass
  - P5 Food growing plant
  - P6 Rain garden
  - P7 Native hedgerow

- TREES**
- T1 Street tree
  - T2 Feature tree
  - T3 Small tree

NOTES

1. All planting to be used in conjunction with all other measures to reduce noise and vibration from the design.
2. All trees to be retained or replaced with a tree of similar or greater value to the one being removed.
3. All trees to be retained or replaced with a tree of similar or greater value to the one being removed.
4. All trees to be retained or replaced with a tree of similar or greater value to the one being removed.
5. All trees to be retained or replaced with a tree of similar or greater value to the one being removed.
6. All trees to be retained or replaced with a tree of similar or greater value to the one being removed.
7. All proprietary products to be used in accordance with manufacturer's instructions.
8. Plant numbers are on individual only and plants should be ordered to suit site areas in accordance with relevant plant schedules.
9. Any proposed plant installation shall be agreed with the landscape architect prior to starting.



**markingham martin**

Unit 2, Floor 2, Building C1, Design Centre  
 100 Brook Hill  
 100 Brook Hill  
 100 Brook Hill

Client  
 Hill Group  
 Project name  
 Forshaw Road Cambridge  
 Drawing title  
 Planting GA  
 Drawing number  
 For Planning







DATE	ISSUE	NO.	DESCRIPTION
1/20	CP	1	24/05/2023
2/23	CP	2	24/05/2023
3/23	CP	3	24/05/2023

DRAWING NUMBER  
**TM520-LA106**

ISSUE NO.  
 #

# Design Proposal

## 4.6 Materiality - Apartments

-  1: Parapet Detail.
-  2: Balcony railings panel Detail.
-  3: Pale white brick with off-white mortar joints.
-  4: Dark brown bricks with white mortar joints.
-  5: Champagne metalwork and vent panels
-  6: Example of protruding brick banding entrance areas.

Page 18



# Design Proposal

## 4.6 Materiality - Houses




1:  
Grey roof tiles



2:  
Example of protruding brick banding entrance areas.



3:  
Pale white brick with off-white mortar joints.

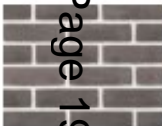

4:  
Dark brown bricks with white mortar joints.

Page 19



# Design Proposal

## 4.6 Materiality - Windows and Balconies

Page 20



2. Champaign coloured Windows within darker brick areas & Balcony Metalwork



1. Brown/ black Window frames

Windows and doors are dark brown/ black. Rainwater goods and parapet trims will be a matching light grey.

Balconies are steelwork structures with metal handrails. Only corner balconies will have circular posts. Circular posts will be same colour as the balconies. Balustrades are metal balustrades with solid panels having a metal powder coat finish panel. This retains a sense of enclosure when one is seated on the balcony.

We propose a sample selection of the colours for windows and rainwater goods.

# Technical Detail

## 6.1 Accessibility M4(3)

All homes in the proposal are designed to meet Building Regulations AD M4(2) Accessible and Adaptable dwelling standard, which means all homes are accessible to any visitors using wheelchairs.

Four of the homes are designed to meet Building Regulations AD M4(3) Wheelchair use dwelling standard. This means that anyone using a wheelchair is able to live in these flats.

The drawings on the right show how the design of a wheelchair occupied 1B2P flat and a 2B4P flat would meet the M4(3) AD standards such as:

- Minimum corridor widths with minimum clear opening width of doors, including 300mm nibs to leading edges and 200mm to the following edge.

- Clear access zones in each room with furniture as required within AD M4(3) Appendix D.


- Bathroom and layout designed as example set within AD M4(3).

- Wheelchair storage in the hallway.

- Wheelchair accessible bathroom and second WC.


- Storage sizes as per M4(3) Standards and space standards

- Minimum combined floor area for living dining and kitchen space

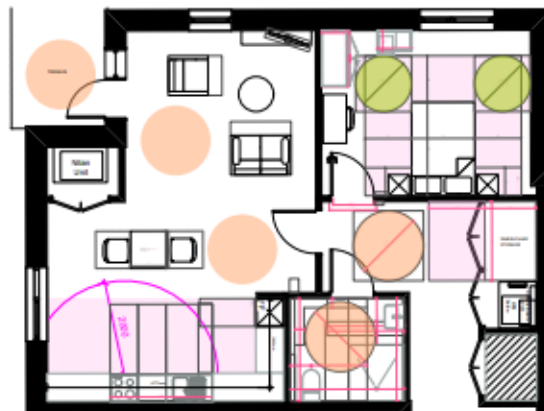

	GIA (S.M.)	Space (S.M.)
GF	84	2.5
FF	0	0
SF	0	0
<b>TOTAL</b>	<b>84</b>	<b>1.6</b>
<b>NDSS</b>	<b>50</b>	<b>1.5</b>
Part M category:		<b>M4(3)</b>

- 1200 mm turning circle
- 1500 mm turning circle
- Space requirement clear zone
- Storage

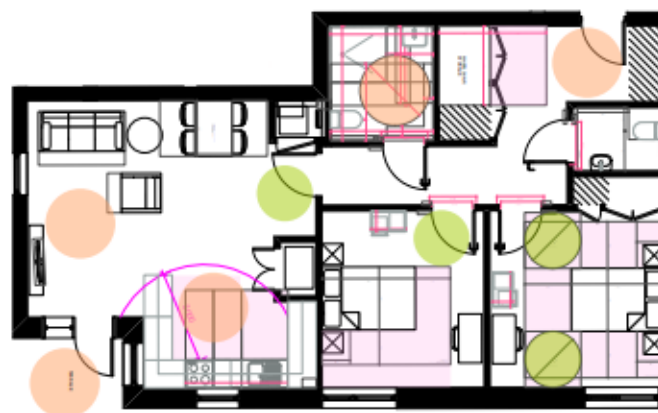

	GIA (S.M.)	Space (S.M.)
GF	91	2.5
FF	0	0
SF	0	0
<b>TOTAL</b>	<b>91</b>	<b>2.6</b>
<b>NDSS</b>	<b>70</b>	<b>2</b>
Part M category:		<b>M4(3)</b>

- 1200 mm turning circle
- 1500 mm turning circle
- Space requirement clear zone
- Storage

Page 21


# Technical Detail

## 6.2 Apartment Aspects


Right is a schedule of the homes on site and a definition of whether they are a single, dual, enhanced dual aspect or triple aspect homes. A dual aspect home is a home that provides openings on two external wall faces. An enhanced dual aspect definition is a home that provides openings on two external wall faces which are opposite each other/ provides through ventilation of spaces.

Overall the scheme has just 13 single aspect homes with 85% of the scheme being dual aspect or better.


Note plans are not to scale.

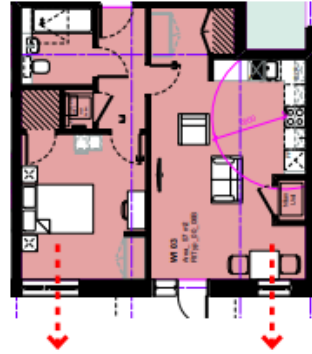


Example of a Single Aspect Apt.

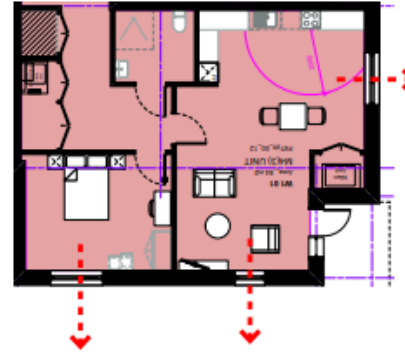

Example of a Dual Aspect Apt.

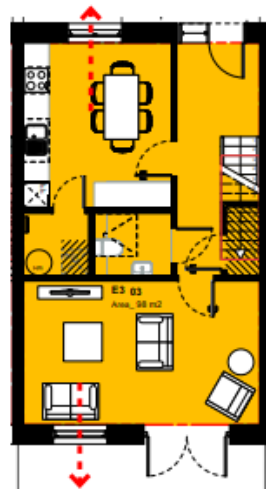

Example of an enhanced Dual Aspect Home

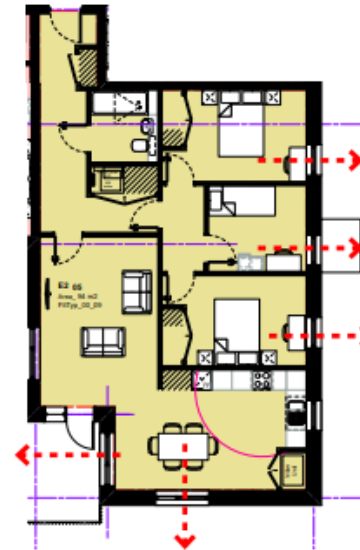

Example of a triple aspect Apt.

	W1	1B2P	2B4P	3B5P	Total
Single Aspect		9			9
Dual Aspect		10	5	4	19
Enhanced Dual Aspect					0
Triple Aspect					0
<b>Total</b>		<b>19</b>	<b>5</b>	<b>4</b>	<b>28</b>

	W2	1B2P	2B4P	3B5P	Total
Single Aspect					0
Dual Aspect		1	10		11
Enhanced Dual Aspect					0
Triple Aspect			3		3
<b>Total</b>		<b>1</b>	<b>13</b>	<b>0</b>	<b>14</b>

	W3	1B2P	2B4P	3B5P	Total
Single Aspect					0
Dual Aspect					0
Enhanced Dual Aspect				1	1
Triple Aspect				2	2
<b>Total</b>		<b>0</b>	<b>0</b>	<b>3</b>	<b>3</b>

	E1	1B2P	2B4P	3B5P	Total
Single Aspect					0
Dual Aspect		1	12		13
Enhanced Dual Aspect					0
Triple Aspect			4		4
<b>Total</b>		<b>1</b>	<b>16</b>	<b>0</b>	<b>17</b>

	E2	1B2P	2B4P	3B5P	Total
Single Aspect		4			4
Dual Aspect			4	2	6
Enhanced Dual Aspect					0
Triple Aspect			4	3	7
<b>Total</b>		<b>4</b>	<b>8</b>	<b>5</b>	<b>17</b>

	E3	1B2P	2B4P	3B5P	Total
Single Aspect					0
Dual Aspect					0
Enhanced Dual Aspect				3	3
Triple Aspect				2	2
<b>Total</b>		<b>0</b>	<b>0</b>	<b>5</b>	<b>5</b>

	Total	%
Single Aspect	13	15.5
Dual Aspect	49	58.3
Enhanced Dual Aspect	4	4.8
Triple Aspect	18	21.4
<b>Total</b>	<b>84</b>	<b>100</b>

# Technical Detail

## 6.3 Sustainability

The proposed development encourages residents to lead more sustainable lives and has also integrated measures designed to reduce energy demand. Targets from the Cambridge Sustainable Housing Design Guide 2021 have informed the sustainable approach for the scheme.

- Affordable homes designed using PassivHaus principles.
- Fabric first approach to the scheme. Affordable homes heated by compact units and air source heat pumps.
- No natural gas supply, fully electric scheme.
- Ventilation strategy provides secure ventilation through louvered windows at ground level.
- Solar shading to top floor openings & balcony overhangs provide shading to glazed doors.
- Green roofs on apartment buildings will assist with rainwater attenuation and the biodiversity.
- Cycle parking has been given priority over car parking.
- Underground bins provided which require less pick-ups reducing the carbon footprint.
- Less than 1 car space per apartment to promote sustainable travel. Car parking bays located away from the centre of the site to promote bike and pedestrian travel. All carspaces have EV charging.
- Lower water consumption targeting 99 litres per person per day.
- A SUDS strategy has been integrated into the landscape design.
- Medium and mature tree types have been selected to provide varied trees to the new green space. Site layout aims to maximise existing tree retention.
- Food growing areas will be provided to new residents in raised beds and an area of wildlife planting will be integrated into the landscape design.
- Targeting +20% biodiversity net gain on the site.
- Durable, attractive external materials have been specified to ensure the buildings age gracefully with minimal maintenance requirement.



Solar design optimised for winter sunlight and daylight providing energy efficiency and wellbeing. Solar shading incorporated above big openings on uppermost floors

New central access into Coleridge recreation ground for convenient pedestrian and bike routes

All homes have views to green spaces

Grow your own! builds community, attracts wildlife and is fun for kids

Promoting a fabric first approach to energy. Efficient building form factors and massing

- Biodiverse SUDS incorporated into landscape design
- less than 1 carspace per apartment to promote sustainable travel. Electric charging points for all vehicles
- Communal and private amenity space
- Retaining existing mature trees on site and large new trees as part of the BNG strategy



- bikes stores integrated into apartment blocks and bike sheds at front of houses
- Specification of low energy lighting and equipment
- Targetted renewables as part of energy scheme, using solar PV and Air Source Heat Pumps
- Use of low volume water fittings
- Low toxicity materials & finishes

Public paths and cycle routes at the heart of the site connected to wider desire lines promoting walking and cycling over cars.

Common spaces and play area facilitates social exchange

Cars are clearly separate from the central green space, which means Emma can play out there with her friends

It's so good that I've got somewhere to lock my bike up, and easy cycle routes to Cherry Hinton and into the city centre.



	Movement
	Reduced Carbon Energy
	Health and Happiness
	Nature
	Resources
	Sustainable Water Use
	Sustainable Food

## 6.5 Private Amenity Space

Apartment balcony sizes meet the following areas :

1bed 2 person apartments - 5m<sup>2</sup> balcony

2bed 4 person apartments - 7m<sup>2</sup> balcony

3bed 5 person apartments - 8m<sup>2</sup> balcony


These provides amenity space for dining table and or seating on balconies.

Ground floor apartment gardens are appropriately sized for the number of occupants in apartments. Refer to the landscape design plan for reference.


House amenity spaces

Each house has external amenity space to the front and rear of the house. Each front garden is provided with a tree and storage. Each house also has one on plot car parking space with ev charge point for the vehicle.

Rear gardens length are typically 8 metres long on E3 and 18metres long for W3 plus lane access to the rear of the gardens.

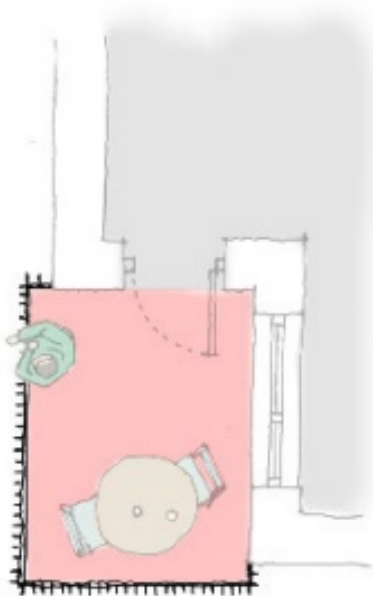

Example of 5m<sup>2</sup> Balcony

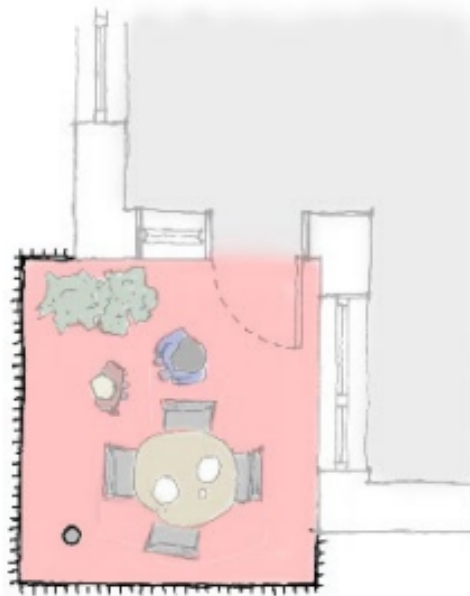

Example of 8m<sup>2</sup> Balcony



Example of private amenity space outside houses



TENURE	BUILDING	1B2P	2B4P	3B5P	TOTAL
AFFORDABLE	W1	19	5	4	28
MARKET	W2	1	13		14
MARKET	W3			3	3
MARKET	E1	1	16		17
AFFORDABLE	E2	4	8	5	17
MARKET	E3			5	5
<b>TOTAL</b>		25	42	17	84
<b>OVERALL SPLIT</b>		30%	50%	20%	
<b>Affordable Split</b>		23	13	9	45
		51%	29%	20%	
<b>Market Split</b>		2	29	8	39
		5%	74%	21%	

SUMMARY AREA SCHEDULE			
Type	m2 Size (NPPF)	Market	Affordable Units No.
1B2P	50	2	23
2B4P	70	29	13
3B5P (APARTMENT)	86	0	9
3B5P (HOUSES)	97	8	0
<b>Total</b>		39	45
<b>Total Affd M4 (3)</b>	4 (2.25 required)		
<b>Total Bike Spaces Req.</b>	160		
<b>Total Car Spaces Req.</b>	50.5		
<b>Total GIA (m2)</b>	3744.4		
<b>Total Dual aspect</b>	85%		

# Design Proposal

## 4.3 Street View - Fanshawe Road looking west



Page 26

VP16

Fanshawe Rd

Page 27



VP16, Before

VP16

Fanshawe Rd

Page 28



VP16. Full Colour

VP15

Sterne  
Close

Page 29



VP15. Before



VP 15

Sterne  
Close

Page 30



VP15. Full Colour

VP14

Bancroft  
Close

Page 31



VP14. Before

VP14

Bancroft  
Close

Page 32



VP14, Full Colour



# VP05

Coleridge  
Recreation  
Ground

Page 33



VP05. Before

# VP05

Coleridge  
Recreation  
Ground

Page 34



VP05, Full Colour

## 23/03653/S73- Aylesborough Close

Section 73 to vary condition 2 (approved drawings) to amend the approved refuse strategy of ref: 22/01995/FUL.



Blocks A and C - Ground Floor Plan



Blocks A and C - First Floor Plan




Key Plan






# Block B – Bin store and cycle parking as proposed


Page 39

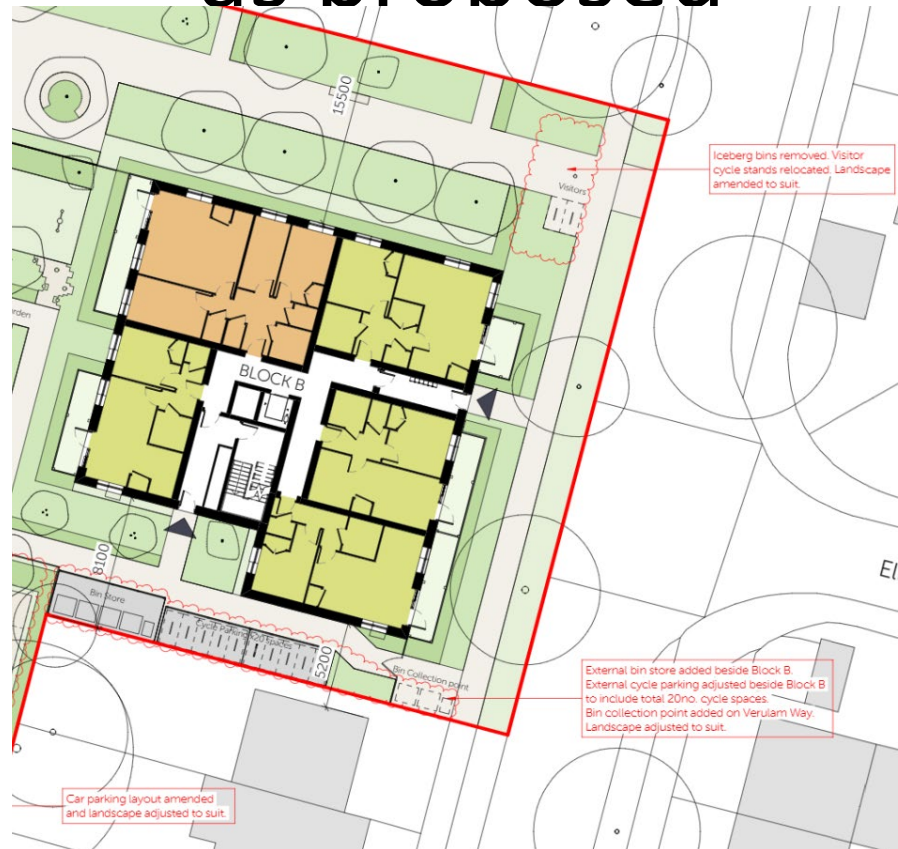


## External cycle store to serve block A

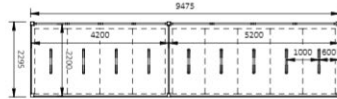


Block A Cycle Parking - Plan

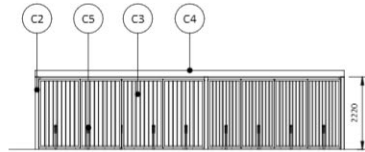


Front Elevation (West)

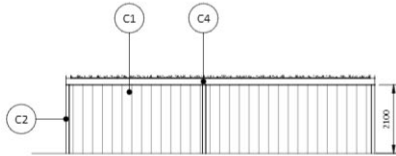

Rear Elevation (East)

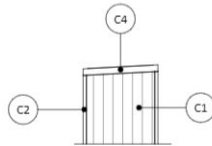

Side Elevation (North)

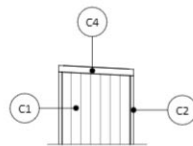

Side Elevation (South)

Materials Key	
<b>Cycle Storage Unit</b>	
C1	Timber cladding
C2	Steel frame construction
C3	Metal gates with foot entry, soft close
C4	Green roof with slight pitch
C5	Sheffield stands, fixed into the ground



Key Plan

**Notes:**  
 Do not use. All dimensions are in millimetres unless otherwise stated.  
 This drawing should be read in conjunction with all relevant project information and contract documentation. All dimensions to be checked prior to fabrication and/or commencement of works. All works to comply with all relevant safety standards, building regulations and warranty (if/where) requirements. Report any discrepancies, if in doubt ask.

Revisions	Rev.	Status	Date	Description	Drawn	Checked
	001	ISS	12/12/23	Issue drawing to suit Section 73 Amendments. External cycle store for Block A added to provide 610 Sheffield stands with top 5800 cycle spaces.		ES

Client Name:	Cambridge Investment Partnership		
Project Name:	Aylesborough Close Phase 2		
Drawing Name:	External Cycle Parking Proposed Plans & Elevations (Block A)		
Drawing Number:	41C-07119-004-00-01-010	Rev:	001
Project No:	20-283	PKA Stage:	3
		Drawn By:	ES
		Scale:	1:100 @ A3


**PLANNING ISSUE**

40 Norman Road,  
 Greenwich, London  
 SE10 9QX  
 t: 020 8293 5175  
 info@btp.co.uk







# External cycle store to serve block B

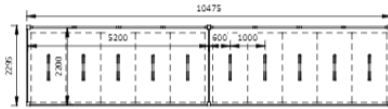


Block B Cycle Parking - Plan

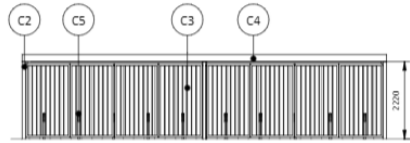


Front Elevation (North)

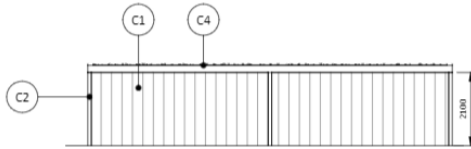

Rear Elevation (South)

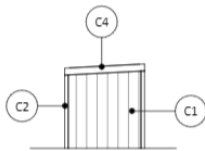


Side Elevation (East)

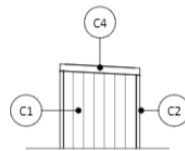

Side Elevation (West)

Materials Key	
<b>Cycle Storage Unit</b>	
C1	Timber cladding
C2	Steel frame construction
C3	Metal gates with top entry, soft close
C4	Green roof with slight pitch
C5	Shelflife stands, fixed into the ground

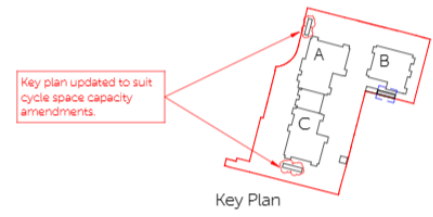

Key Plan

**Notes:**  
 Do not scale. All dimensions are in millimetres unless otherwise stated.  
 This drawing should be read in conjunction with all relevant project information and contract documentation. All dimensions to be checked prior to fabrication and/or commencement of works. All works to comply with all relevant legal standards, building regulations and warranty provider requirements. Report any discrepancies, if in doubt ask.


Rev	Status	Date	Description	Drn	Chkd
001	A3	13.04.23	Planning issue	JPL	
002	A3	31.08.23	Section 79 Amendments. Volume of model changed to suit. Capacity of cycle store amended. Key plan amended.	ES	
003	A3	08.11.23	Section 79 Amendments. Double-stacked cycle spaces removed from internal cycle store and replaced with shelflife stands. Key plan amended.	ES	

Client Name:		Cambridge Investment Partnership	
Project Name:		Aylesborough Close Phase 2	
Drawing Name:		External Cycle Parking Proposed Plans & Elevations (Block B)	
Drawing Number:	AYC-8PT31-05A-XX-DR-A-1007	Rev:	C03
Project No:	20-283	Drawn By:	LL
RIBA Stage:	3	Scale:	1:100 @ A3


**PLANNING ISSUE**

40 Norman Road,  
 Greenwich, London  
 SE10 9QX


t. 020 8293 5175  
 bptw.co.uk

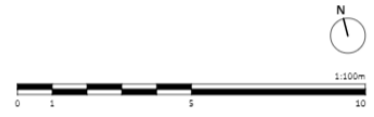


## External refuse store to serve block B

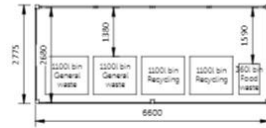


Floor Plan

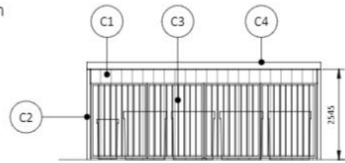


Front Elevation (North)

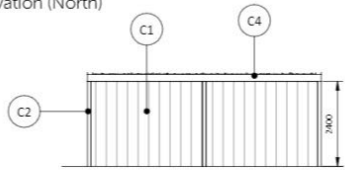

Rear Elevation (South)

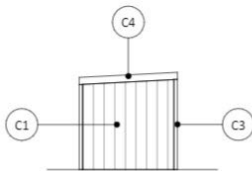

Side Elevation (East)

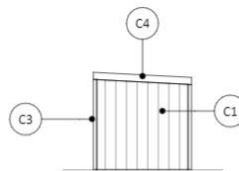


Side Elevation (West)

### Materials Key

#### Bin Store

- C1 - Timber cladding
- C2 - Steel frame construction
- C3 - Metal gates with fob entry, soft close
- C4 - Green roof with slight pitch

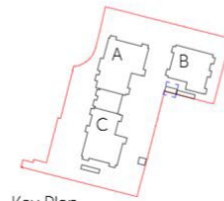

Key Plan


Notes:  
Do not scale. All dimensions are in millimetres unless otherwise stated.  
This drawing should be read in conjunction with all relevant project information and contract documentation. All dimensions to be checked prior to fabrication and/or commencement of works. All works to comply with all relevant legal standards, building regulations and warranty provider requirements. Report any discrepancies, if in doubt ask.

Rev.	Status	Date	Description	Dim.	Chkd.
001	A3	31.08.13	New drawing for section 73 amendments.		ES

Client Name: Cambridge Investment Partnership					
Project Name: Aylesborough Close Phase 2					
Drawing Name: External Bin Store - Proposed Plans and Elevations					
Drawing Number: A/C-BPTW-504-XX-DR-A-1009		Rev:	C03	Status: A3	
Project No: 20-283	RIBA Stage: 3	Drawn By: ES	Scale: 1:100 @ A3		
<b>PLANNING ISSUE</b>					
40 Norman Road, Greenwich, London SE10 9QX					



## External cycle store to serve block C

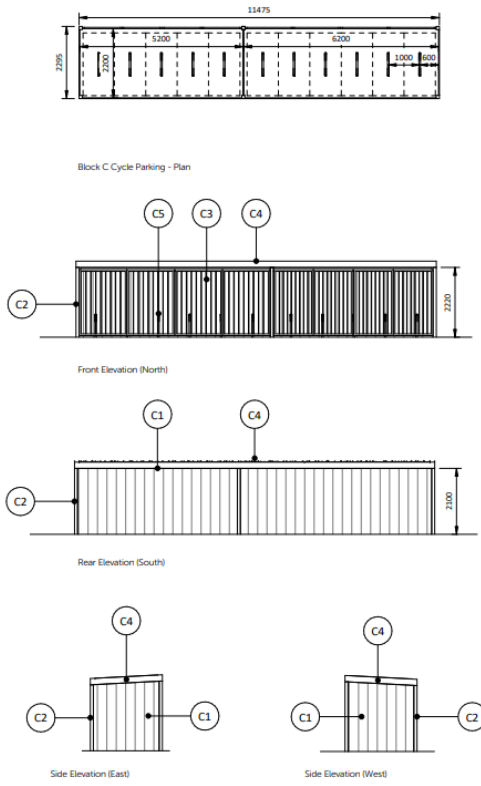

Materials Key	
<b>Cycle Storage Unit</b>	
C1	Timber cladding
C2	Steel frame construction
C3	Metal gates with lobb entry, soft close
C4	Green roof with slight pitch
C5	Shelfed stands, fixed into the ground




**Notes:**  
 Do not scale. All dimensions are in millimetres unless otherwise stated.  
 This drawing should be read in conjunction with all relevant project information and contract documentation. All dimensions to be checked prior to fabrication and/or commencement of works. All works to comply with all relevant legal standards, building regulations and warranty/broader requirements. Report any discrepancies, if in doubt ask.

Rev.	Status	Date	Description	Drawn	Checked
001	A3	08.12.21	New drawing to suit Section 73 amendments. External cycle store for Block C added to provide 11no. specified stands with total 22no. cycle spaces.	ES	

Client Name: Cambridge Investment Partnership	
Project Name: Aylesborough Close Phase 2	
Drawing Name: External Cycle Parking Proposed Plans & Elevations (Block C)	
Drawing Number: ANC-BPTW-SGA-XX-OR-A-1011	Rev: C01
Project No: 20-283	Status: A3
BESA Stage: 3	Drawn By: ES
Scale: 1:100 @ A3	

**PLANNING ISSUE**

40 Norman Road,  
Greenwich, London  
SE10 9XX  
t: 020 8263 5275  
bptw.co.uk

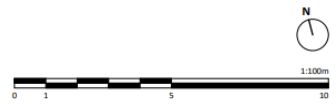

# 23/03519/FUL

## Tyndale House

### Site Location Plan






Page 45



# Proposed Site Plan

Page 47

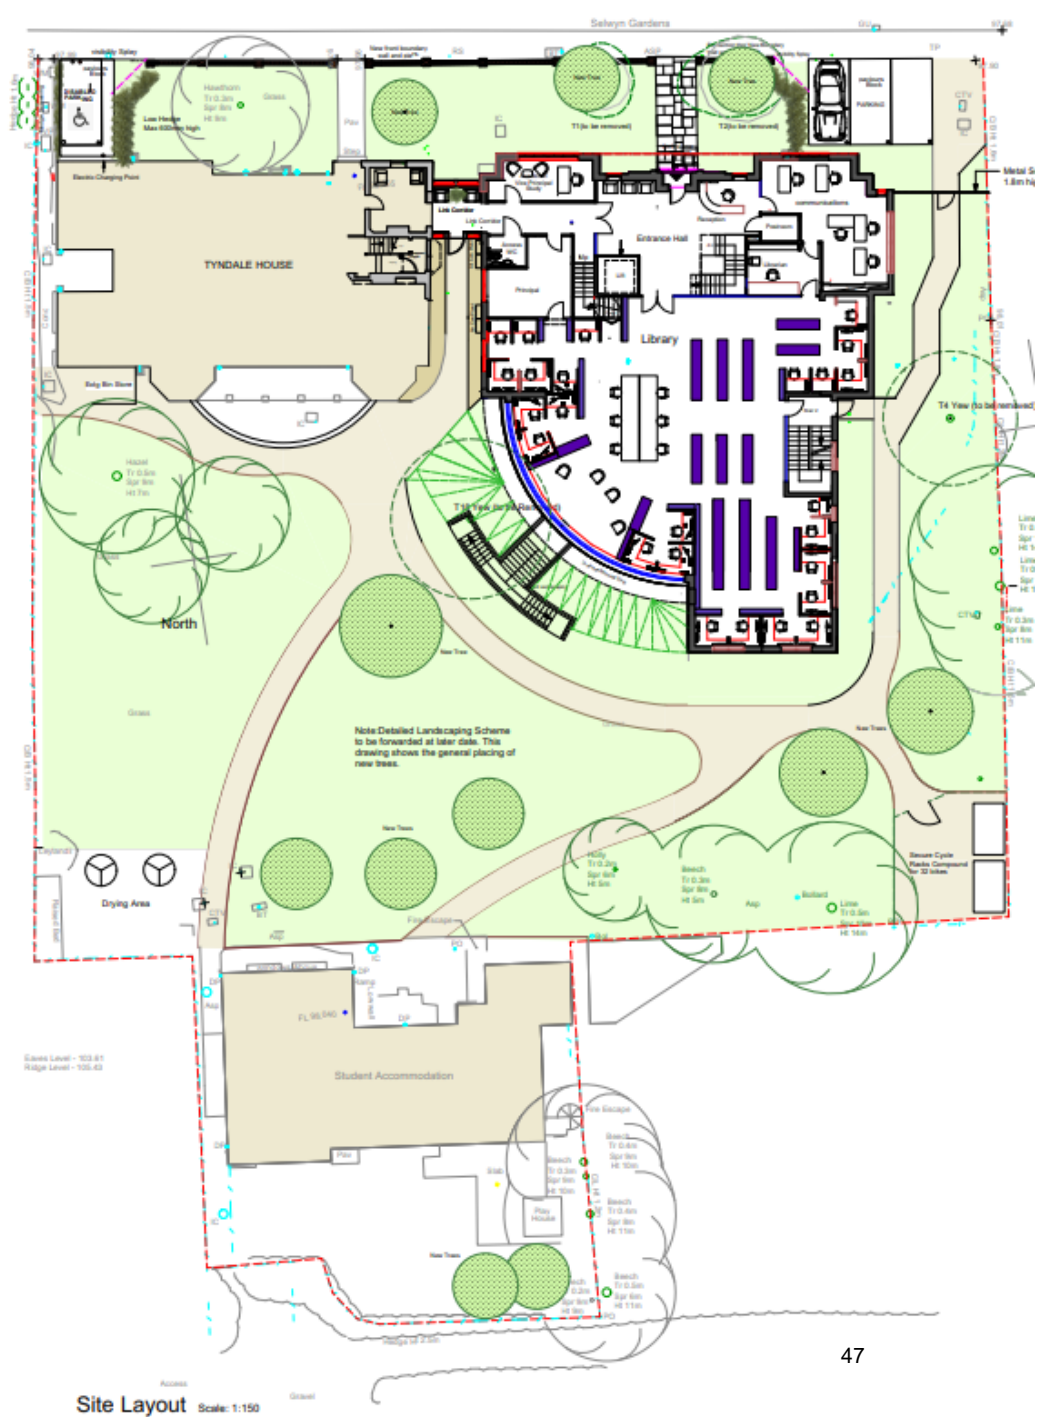

# Proposed Street Scene

Page 48






# Proposed Front (North) and Rear (South) Elevations

Page 49



① Proposed Front Elevation (North)  
1:100

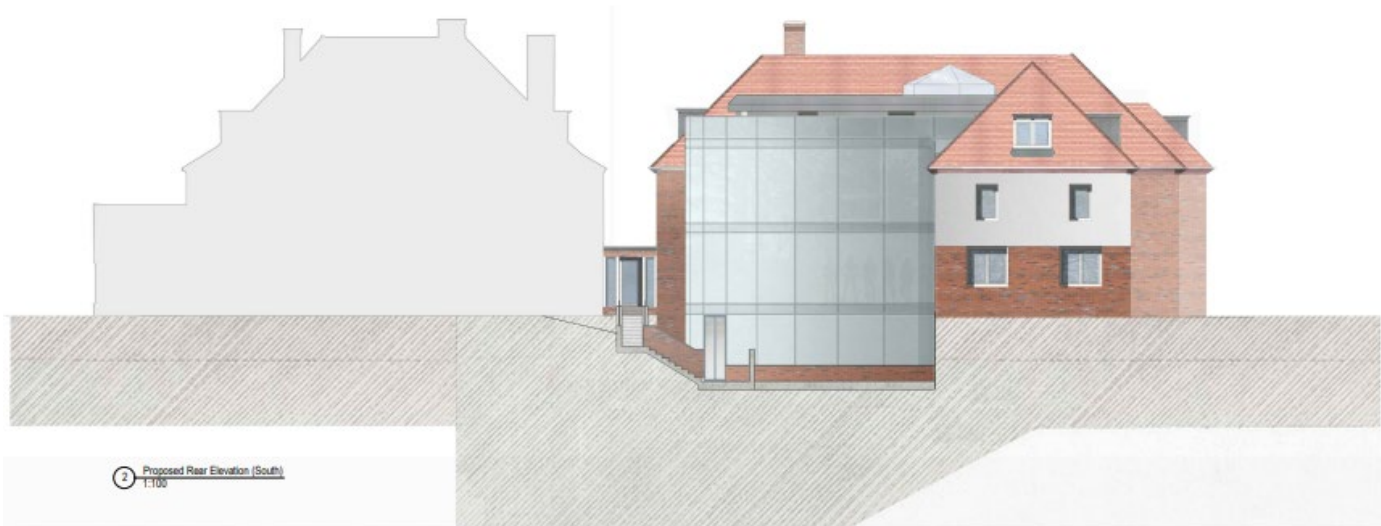

② Proposed Rear Elevation (South)  
1:100

# Proposed Side (West and East) Elevations

Page 50




# Proposed Ground and First Floor Plans


Revisions  
 A. Reposition of  
 B. Plan title area



Ground Floor Plan

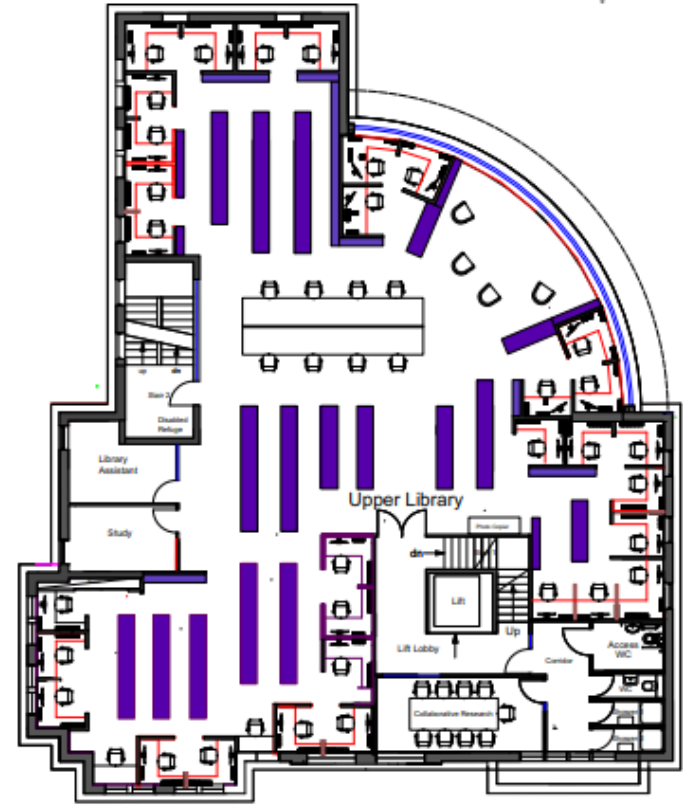


First Floor Plan

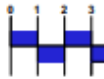


Page 51

T4 Yaw (to be removed)


Revisions	Date:

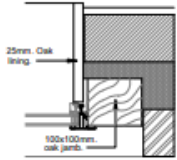


DETAIL AT JAMB.  
SCALE 1:5

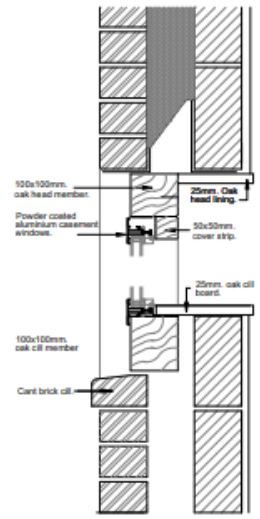


1:5

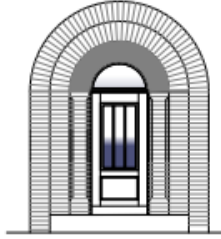


MAIN ENTRANCE ELEVATION  
SCALE 1:20

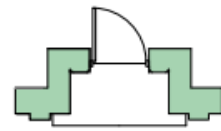

MAIN ENTRANCE PLAN  
SCALE 1:20

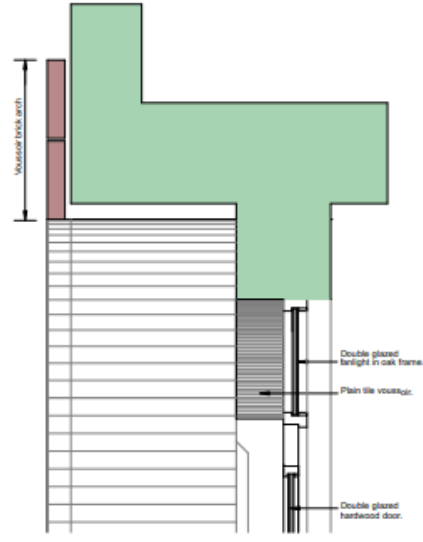


SECTION THROUGH  
MAIN ENTRANCE  
SCALE 1:10

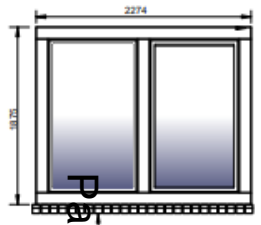


TYPICAL ELEVATION  
OF CASEMENT WINDOW  
SCALE 1:20



Page 52

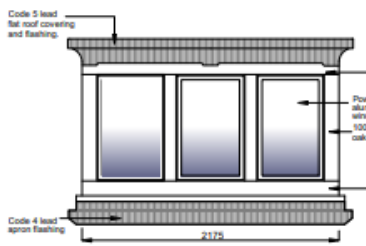

TYPICAL ELEVATION  
OF DORMER  
SCALE 1:20

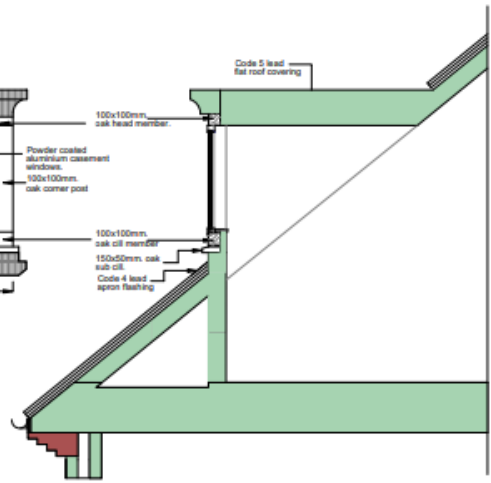

TYPICAL SECTION  
THROUGH DORMER  
SCALE 1:20

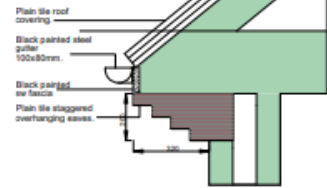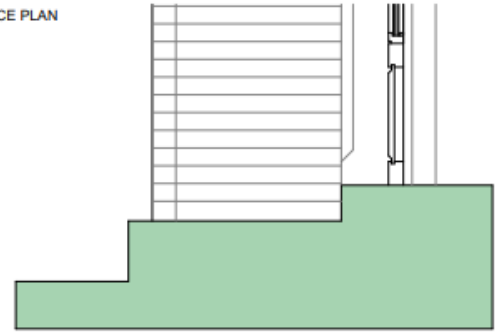

TYPICAL SECTION  
THROUGH EAVES



Scale Bar 1:100 @ A1


Tyndale House  
36 Selwyn Gardens  
Cambridge  
CB3 9BA

Date: April 2023 Scale: Various Drawn: TP  
Drawing Number: **Th 201 72** Project Title:


**DETAILS**  
Dormer Window  
Eaves  
Drawing Title: **Main Entrance  
Casement Window**

**PW**  
Architectural Drawing/Design Services

14, Bounland Close  
Bradley Stoke  
Bristol BS32 4YJ

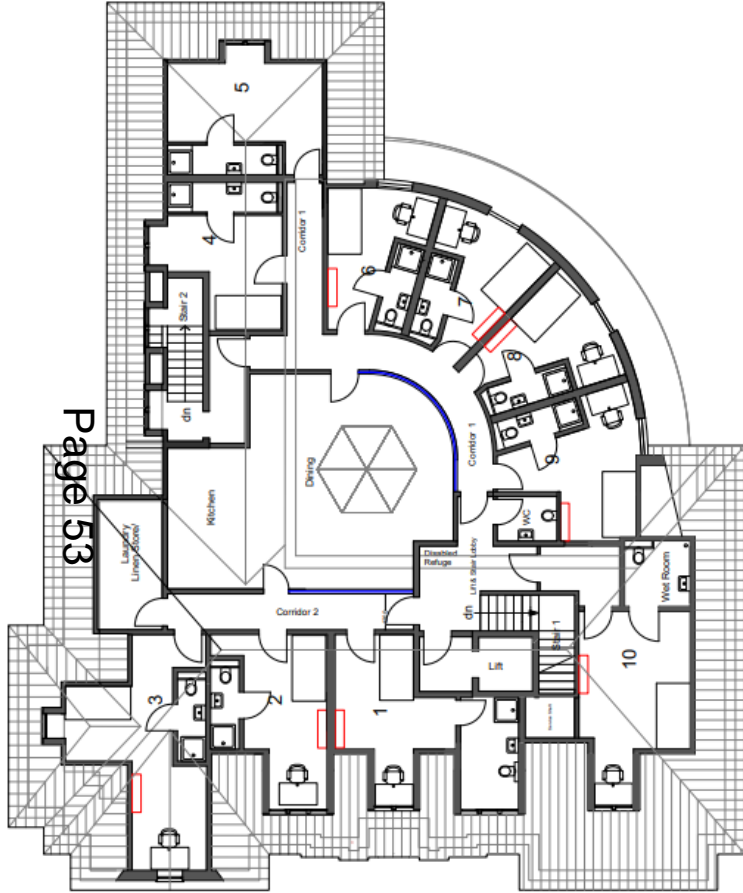

Second Floor Plan

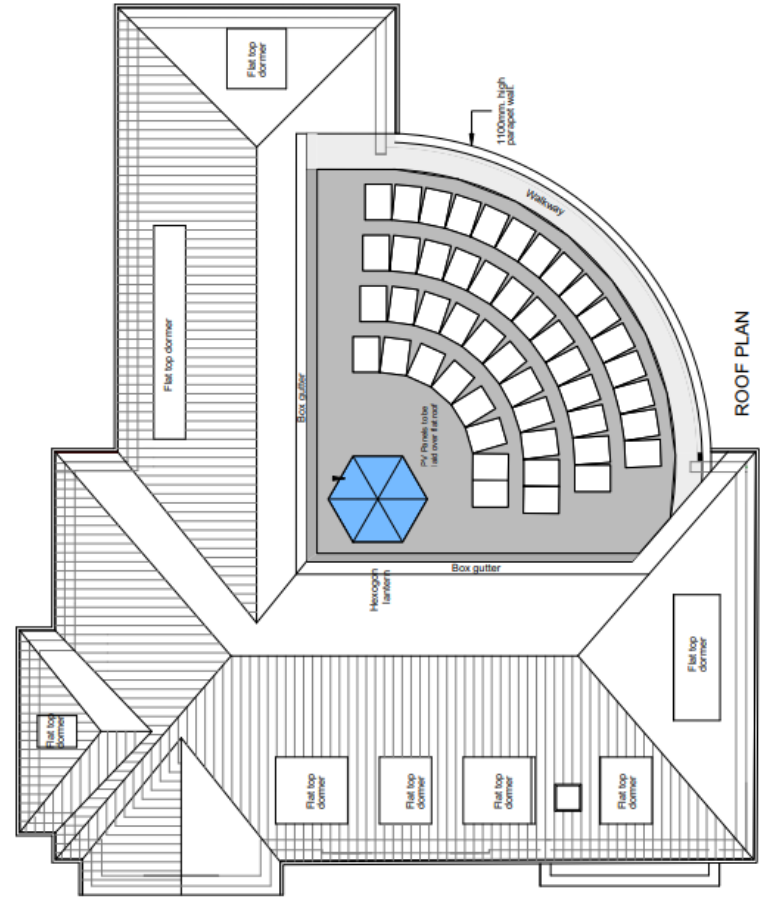

Roof Plan





North Elevation on Selwyn Gardens



Proposed South West Elevation of New Library for Tyndale House 36, Selwyn Gardens Cambridge




# Minor Applications

# 23/03068/FUL




## 163 – 167 Mill Road

Refurbishment of the building including internal slab openings with steel framing, roof replacement, new plant, substation, external alterations and temporary removal of shopfront to facilitate MRI installation (first phase).

# Location Plan

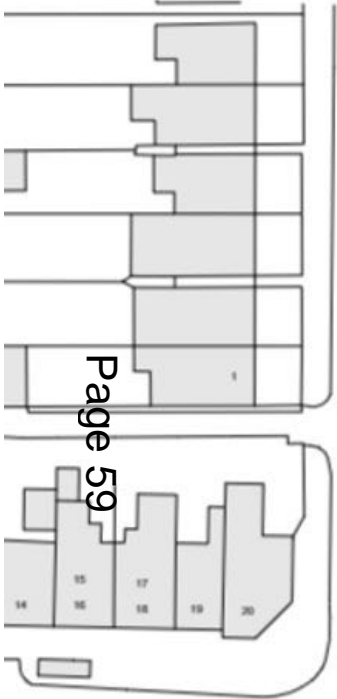

Page 59

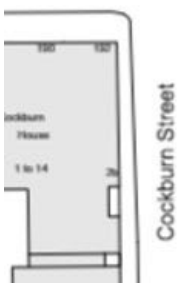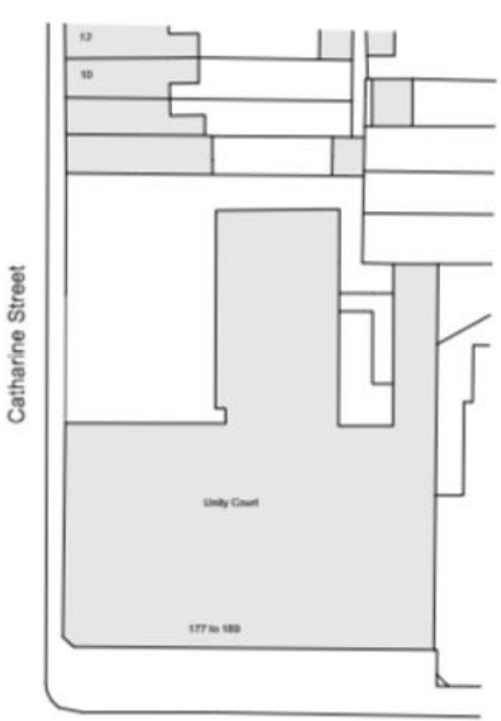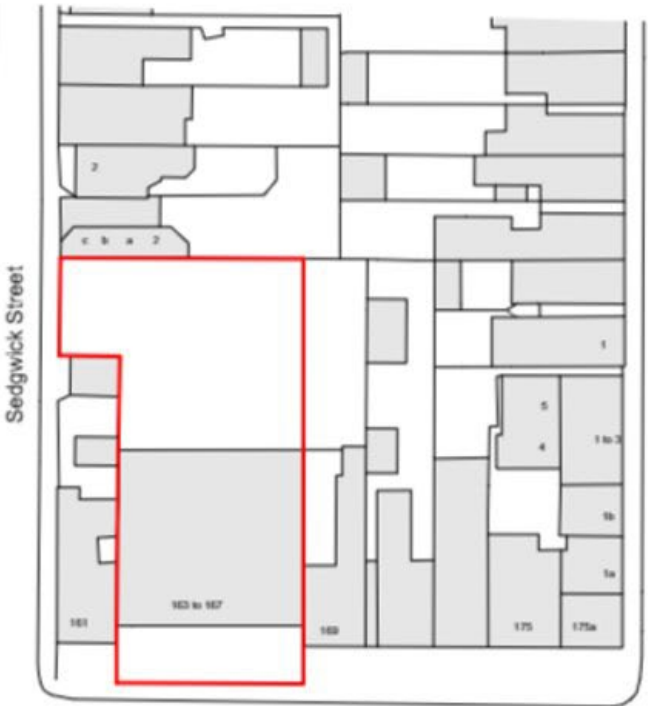

Do not scale from this map for construction purposes




© 2014 by the City of Toronto  
All Rights Reserved



# Site Constraints Map



# Aerial View

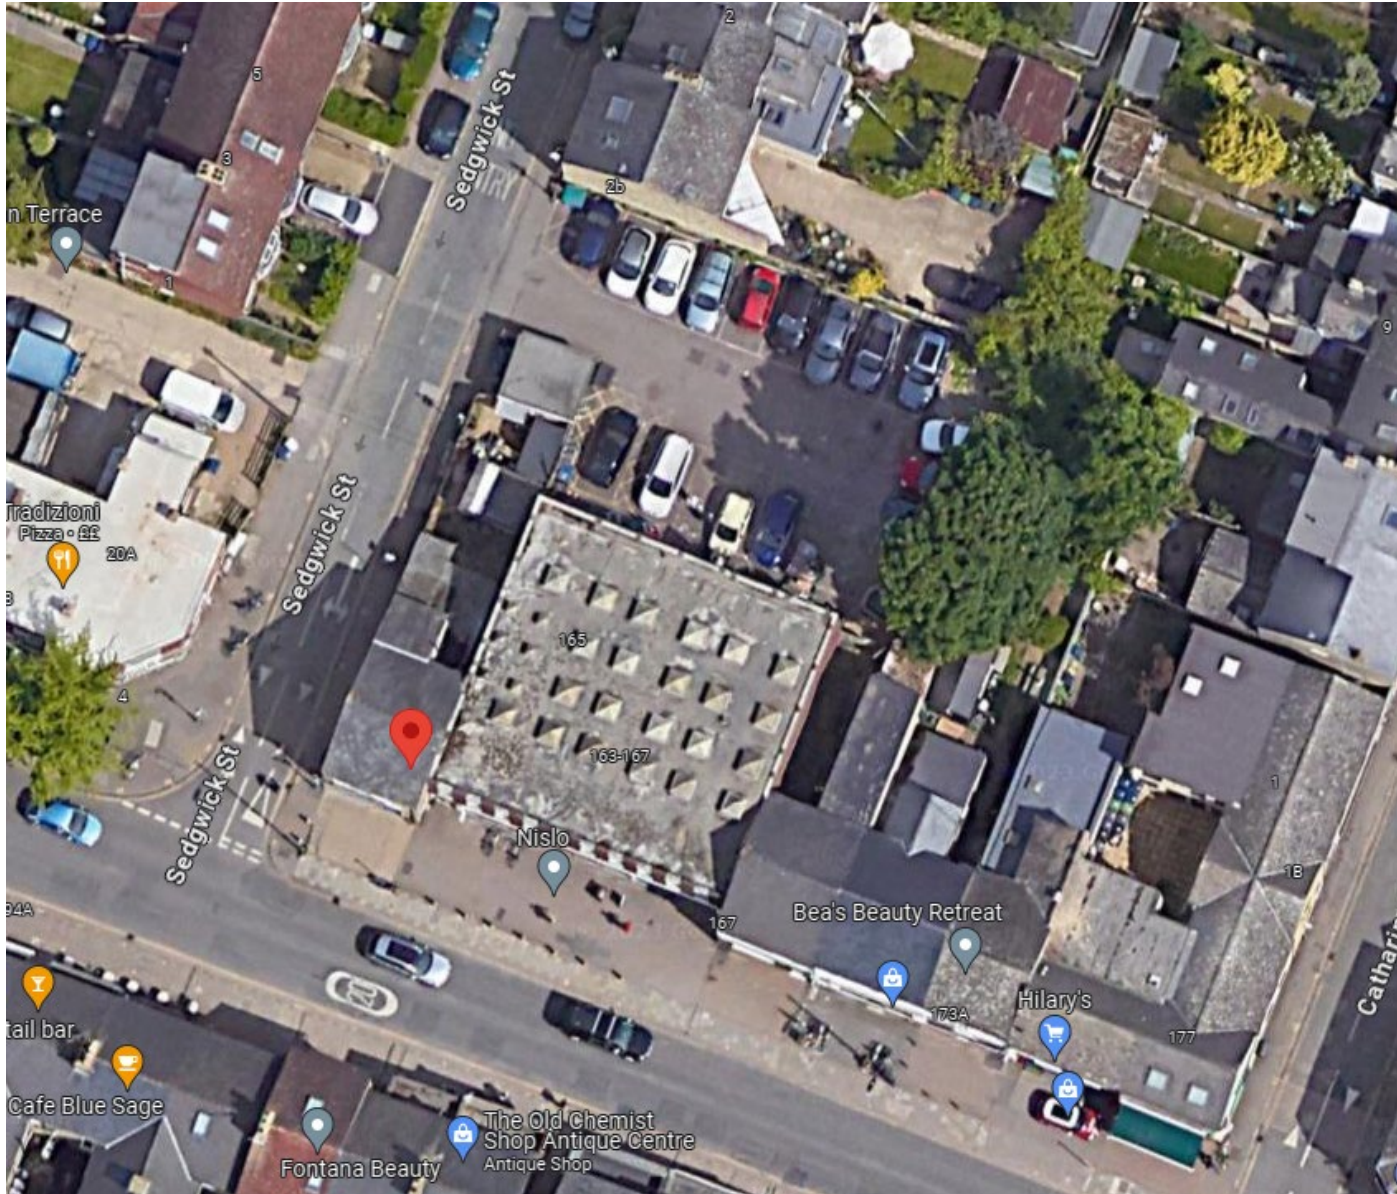

# 3D Aerial View - Rear



Page 62


# Planning History

Reference	Description	Outcome
21/03622/PRI030	Prior approval for change of use from offices (Class B1 (a)) to 4 No. dwellinghouses (Class C3)	Prior Approval Given
14/0963/ADV	Rebranding of Tesco Express retail unit: 2 No. fascia, 1 projecting sign and 10 other signs	Permitted
08/0099/FUL	Erection of single storey rear extension and installation of plant.	Refused – Appeal Dismissed

Page 63

# Existing Site and Ground Floor Plan


Page 64

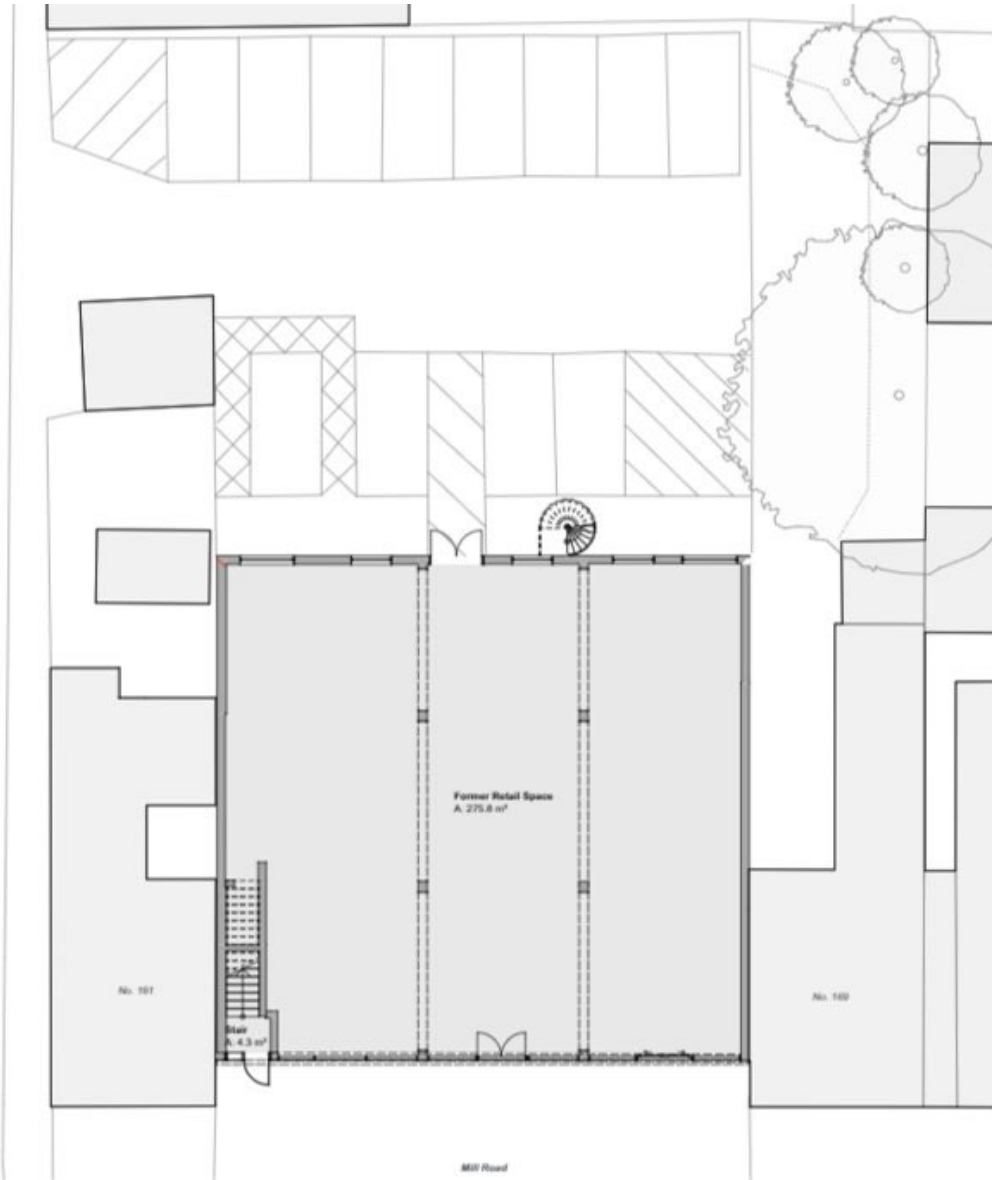



# Proposed Site and Ground Floor Plan


Page 65

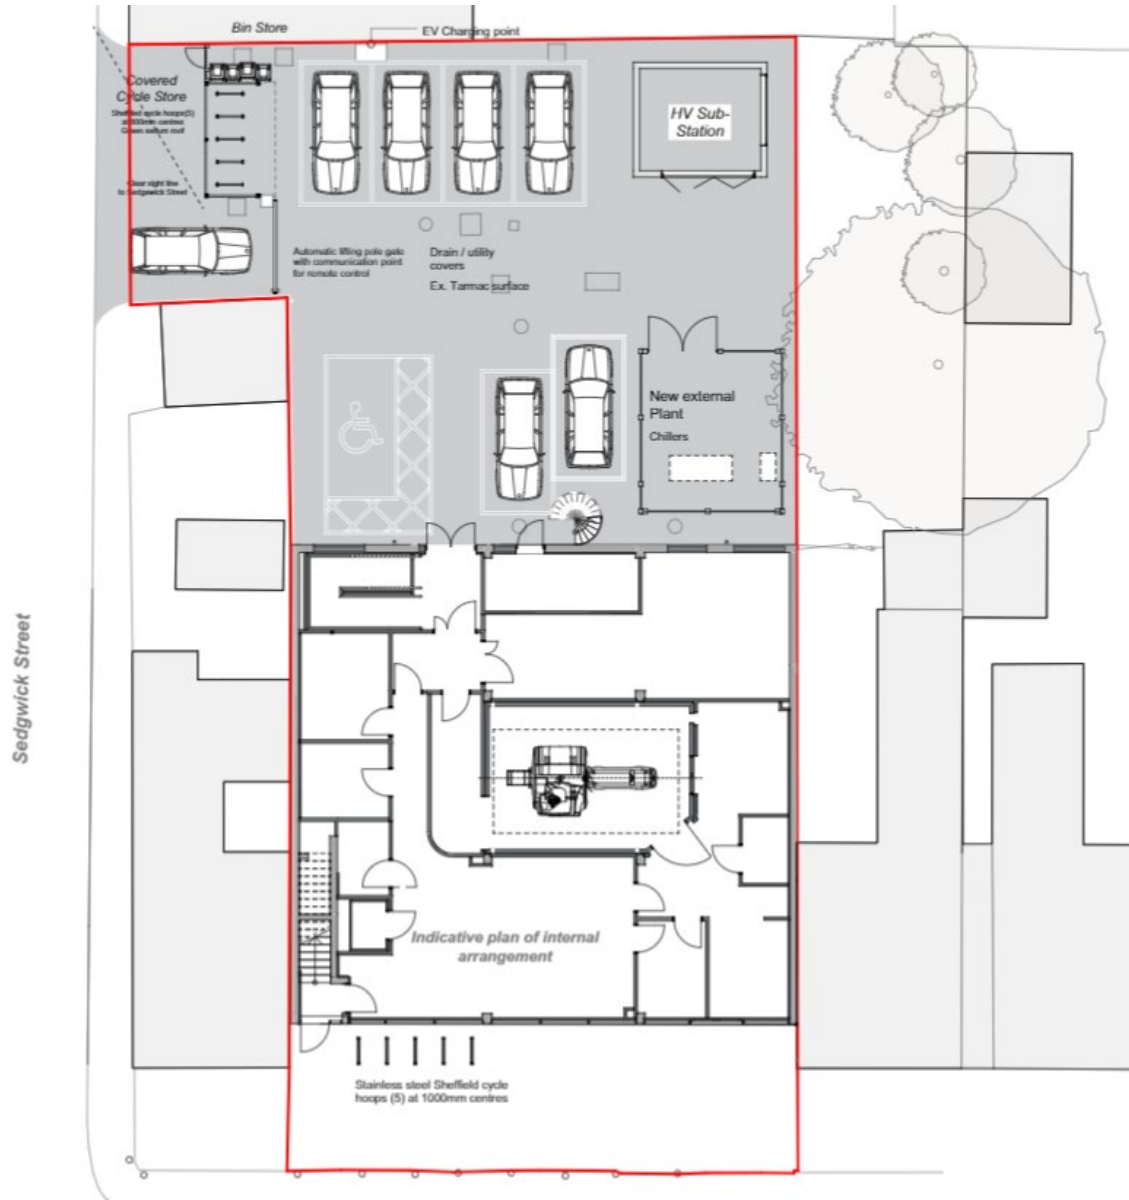

# Proposed Roof Plan

Sedgwick Street

Page 66

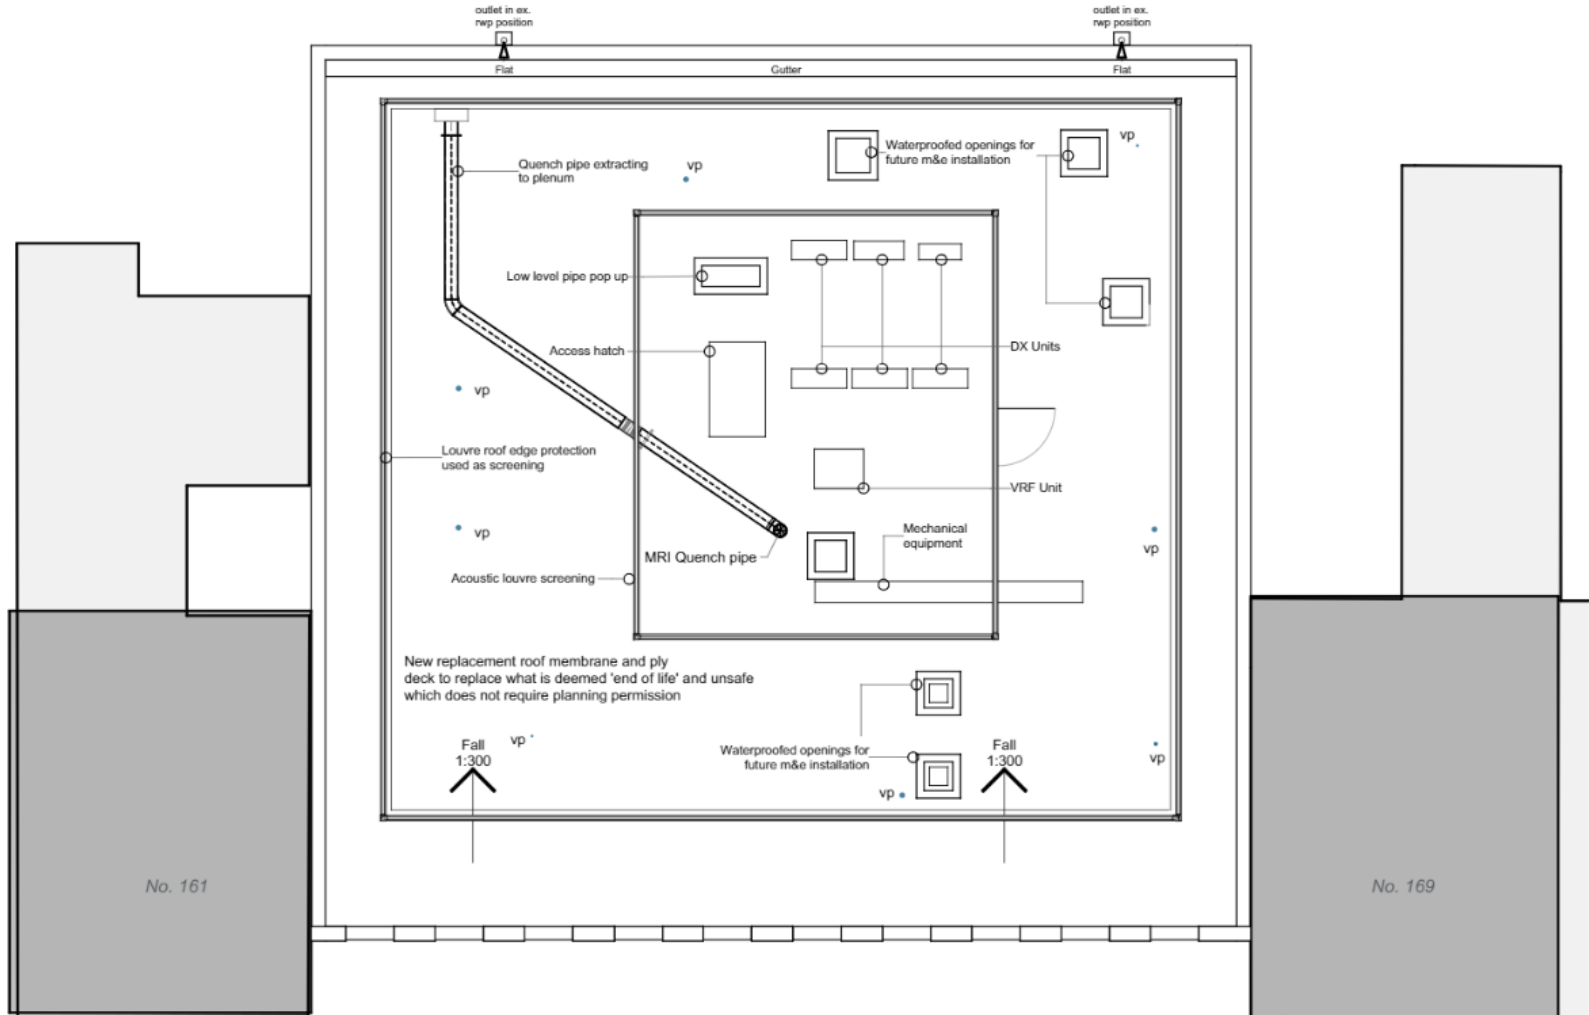

# Existing Front and Rear Elevations

Page 67



E-01 Front Elevation

1:100



E-02 Rear Elevation


1:100

# Proposed Front and Rear Elevations




# Existing Side Elevations

Page 69

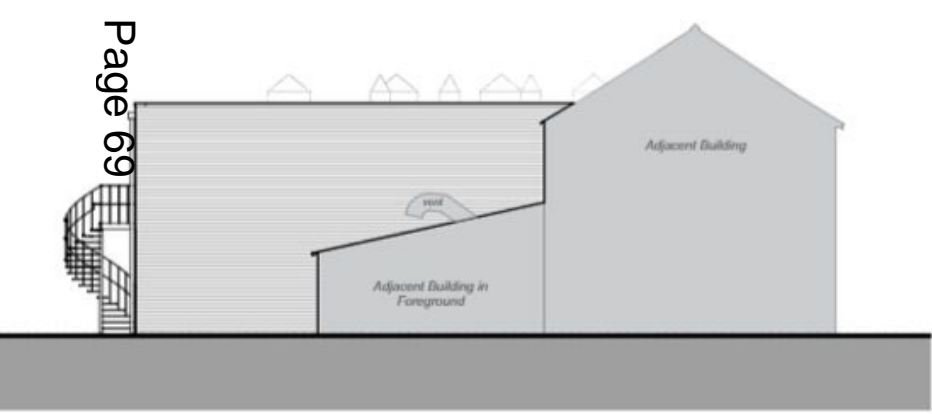

E-03 West Elevation



1:100

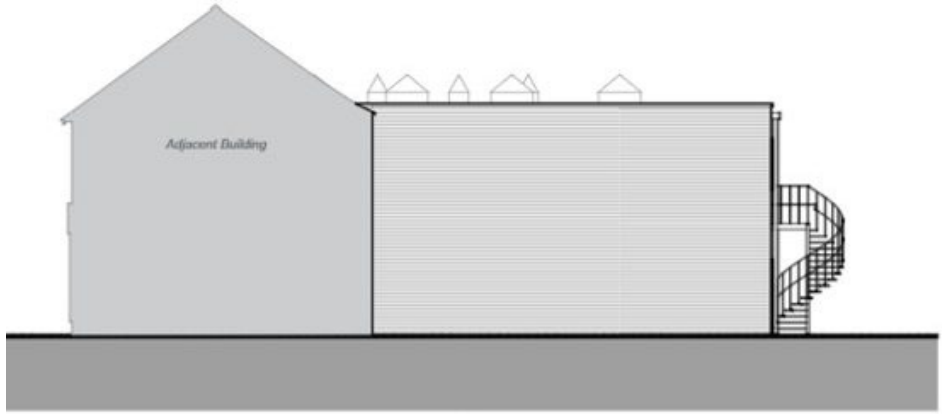

E-04 East Elevation

1:100

# Proposed Side Elevations

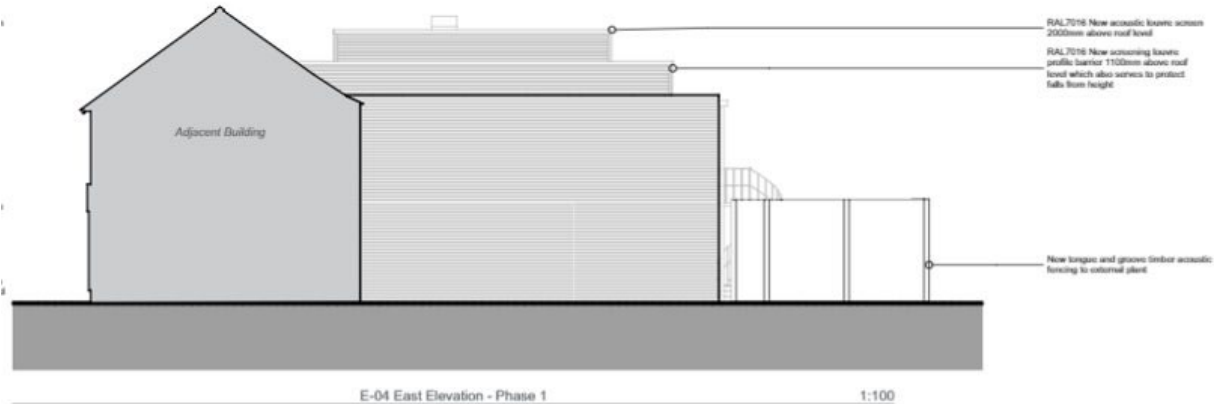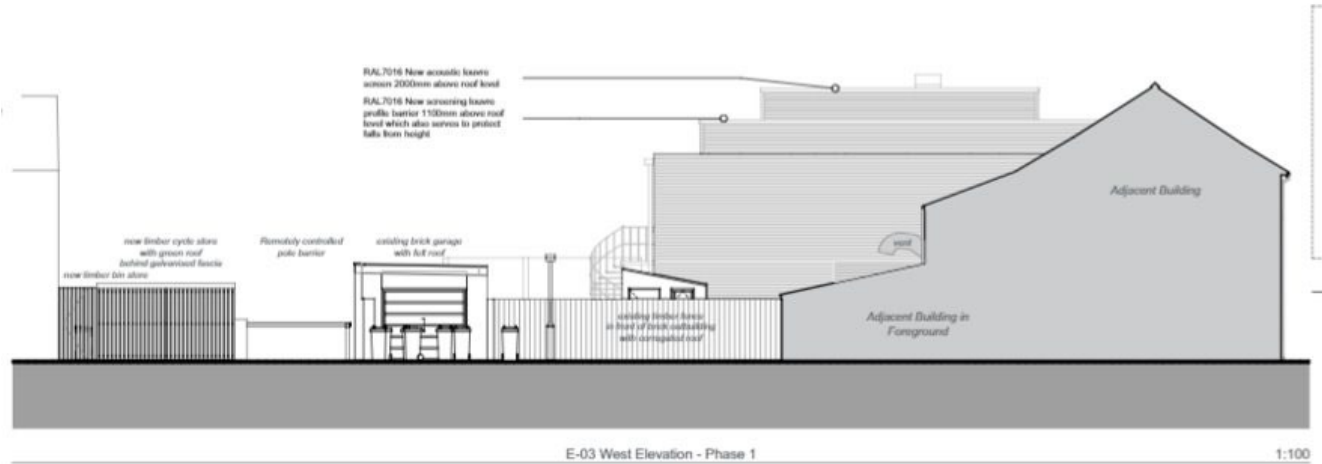

# Proposed Sections



# Streetview Images

Page 72



Google

72







Page 74

Google



Page 75

Google

# Representations

Objections received regarding:

- Use of site
- Impact on character of the area
- Residential Amenity Impact
- Noise impact
- Plant Impact
- MRI being safe in residential area
- No improvement to Landscape/Biodiversity
- Should be a green roof
- Construction Impacts
- Highways/Traffic implications
- Cycle provision

Cllr Baigent objecting relating to:

- Structural Changes to Building
- Residential Amenity impact as a result from plant.
- Petition also received objection to the use of the building as an MRI clinic.

# Consultee Comments

## No Objections

- Conservation Officer
- Local Highways Authority
- Environmental Health
- Sustainability Officer
- Sustainable Drainage Officer

# Change of use – clarification

- The application is not seeking a change of use. The Town and Country Planning (Use Classes) (Amendment)(England) Regulations 2020

Page 78

Shops	
Supermarkets	
Post Offices	
Travel Agencies	
Sandwich Bars	
Hairdressers/Barbers	
Funeral Directors/ Undertakers	A1
Retail Warehouses (Argos etc.)	
Domestic Hire Shops	
Dry Cleaners	
Locations to receive items for cleaning or repair	
Internet Cafés	
Banks and Building Societies	
Estate Agents or Employment Agencies	A2
Restaurants	
Cafés	A3

**Use Class E**  
Commercial, Business and Service

Offices	B1(a)	
Research and Development of products and processes	B1(b)	<b>Use Class E</b>
Light Industrial appropriate in a residential area	B1(c)	Commercial, Business and Service

Doctors, Clinics and Health Centres, Acupuncture Clinics etc. (except where linked to the residence of the practitioner)	D1	<b>Use Class E</b>
Crèches, Day Nurseries or Day Centres		Commercial, Business and Service